



## TECHNICAL PROPOSAL FOR FIXED NETWORK ACCESS

At

FTK New 1W Underground Civil & 1x144F Cable Pulling Infrastructure  
From Bidor – H.Melintang (Package 4)

Leg A : Simpang Tiga (Rumah Pam Labu Kubong)

Lat Long : 4.098231, 101.047803

Leg B : Kampung Perwira Jaya

Lat/Long : 3.992581, 101.022525

Table of Content

**1.0 TP CHECKLIST .....3**

**2.0 GENERAL INFORMATION.....4**

**3.0 PROPOSAL FOR FIXED NETWORK ACCESS .....6**

    3.1 Introduction.....6

    3.2 External and Internal Trenching .....6

    3.3 Equipment Foot Space & Weight .....7

    3.4 Location Map .....8

**4.0 APPENDIX.....9**

    4.1 Product Portfolio.....9

    4.2 Drawing.....10

        4.2.1 Drawing – Site Plan ..... **Error! Bookmark not defined.**

        4.2.2 Drawing - Schematic..... **Error! Bookmark not defined.**

    4.3 Site Photos ..... **Error! Bookmark not defined.**

        4.3.1 Outside and Inside Plant Photos ..... **Error! Bookmark not defined.**

## 1.0 TP CHECKLIST

Building Name : Bidor - Hutun Melintang Package 4				
Date of LOI :				
Date of Survey : 14/04/2026				
	DESCRIPTION	YES	NO	REMARKS
1	TDC existing manhole coordinate	✓		
2	Existing building manhole coordinate	✓		
3	Any Gas pipe signage seen at site? If YES, attach Photo		✓	
4	Any TNB signage seen at site? If YES, attach Photo		✓	
5	Any crossing drainage? If YES, attach photo & width of the drainage		✓	
6	Any INDAH WATER manhole seen at site? If YES, attach Photo		✓	
7	Any crossing traffic light? If YES, attach photo & measurement of the traffic light box		✓	
8	Has identified Local Authority? Kindly indicate.	✓		Dewan Bandaraya Teluk Intan Perak
9	Drawing for outside plant (OSP) survey - Building Access & civil work up to last TIME manhole (dwg format - autocad & .pdf format) *	✓		
10	Drawing for inside plant (ISP) survey - MDF up to riser (.dwg format - AutoCAD & .pdf format) *	✓		
11	Prepare the complete 1 copy of Technical Proposal (.pdf format & Word Format) –of softcopy – 1 copy	✓		
12	Bill of Quantity for civil, fibre pulling, splicing & termination	✓		
13	The latitude & longitude of the building location, last TIME manhole and building manhole in 6 decimal points (xx.xxxxxx, x.xxxxxx) in TP Location Map	✓		
14	Open up the manhole at any spot of joint/ring cut & provide duct space record for this project (photo required). Please make sure that there is TIME cable in the manhole (photo required). <b>If unable to open up the manhole, photo of manhole surrounding is required.</b>		✓	
15	Survey Acknowledgment Form signed & attached		✓	
16	Others			

## 2.0 GENERAL INFORMATION

### General Information

Building Name : Bidor - Hutan Melintang Package 4  
Address: Perak Darul Ridzuan  
Type of Development: N/A  
No of Unit: N/A  
No of Storey/Block: N/A

### Contact Person

#### Management

Name: - H/P: -  
Designation: - Tel: -  
Email Address: -

#### Maintenance / Security Department

Name: N/A H/P: N/A  
Designation: - Tel: -  
Email Address: -

### Comments

For TimeDotCom Bhd Use Only

Remarks :

Prepared by: Amtel Resources Sdn Bhd  
Date of LOI:  
Date of Survey: 14/04/2026  
Surveyed by: Amtel Resources Sdn Bhd  
Drawing Prepared by: Amtel Resources Sdn Bhd  
Eng. Person In charge: Jemi

**Telecommunication Information**

**MDF/SDF Room Description**

Number of MDF/SDF Room: N/A  
 Location of Equipment Room:  
 Number of Fiber Cores Terminated: 144 Cores  
 Number of Splitter Installed: N/A  
 Location of Splitter: N/A  
 Fiber of Termination Type: N/A  
 Power: N/A  
 Method of Access to Building: N/A  
 Method of Exit to Riser: N/A  
 Longitude & Latitude: From : 4.098231, 101.047803  
 To : 3.992581, 101.022525

**Construction Detail**

No	Description	Method	Distance (m)
1	Civil	1W HDD	14480m
	Others		
2	Fiber Pulling 144C		15140m

Comment:

For Contractor Use Only:

For Client Use Only :

## 3.0 PROPOSAL FOR FIXED NETWORK ACCESS

### 3.1 Introduction

- 3.1.1 TIME dot Com offers a wide variety of fixed-line telecommunications services. As part of our commitment to provide our customers with the best possible solutions to serve all their communications needs; we aim to enhance telecommunication services in your building to offer your tenants with High Speed Internet, Data and Voice connectivity. Your premises will be enhanced today for tomorrow's communication and IT requirements. With that, we provide a choice of Service Providers to your tenants and your building gains a future-proof communication infrastructure.
- 3.1.2 A physical infrastructure link to the building is the main access to deliver services to the tenants. The typical link required is through fiber optic cable.
- 3.1.3 In order to support the services, TIME dot Com require an access to the propose MDF room and Telephone Riser in order to provide services to the end user.
- 3.1.4 To be able to deliver these services to your building, we will pull our own fiber optic cables from our nearest hub and place our passive access equipment into building server room. (Optional in this proposal)
- 3.1.5 With this setup we will have TIME dot Com connection right up to each block of the building.

### 3.2 External and Internal Trenching

- 3.2.1 The propose route will start from the existing TdC Mh to Building Mh using new ducting. The propose route then continue to MDF Room/SDF Room/Server Room using existing route.
- 3.2.2 TdC will utilize minimum of 1x100mm existing building access ducting to building retaining wall and existing cable tray to common Server room.
- 3.2.3 The permission to trench inside local authority jurisdiction to be applied separately if necessary.
- 3.2.4 This proposal is based on assumption that there is fiber cable to be connected in the existing TIME manhole.

### 3.3 Equipment Foot Space & Weight


- 3.3.1 Below is the TIME dot com' standard requirement that will be installed at common MDF Room/SDF Room/Server Room.

Description	Remarks
N/A	N/A


- 1.3.2 However depending on the network requirement, Time dot Com may or may not add additional network equipment(s) in the MDF room or the vertical riser as it may apply.

### 3.4 Location Map

Site Plan – KMZ Routing (Manhole)

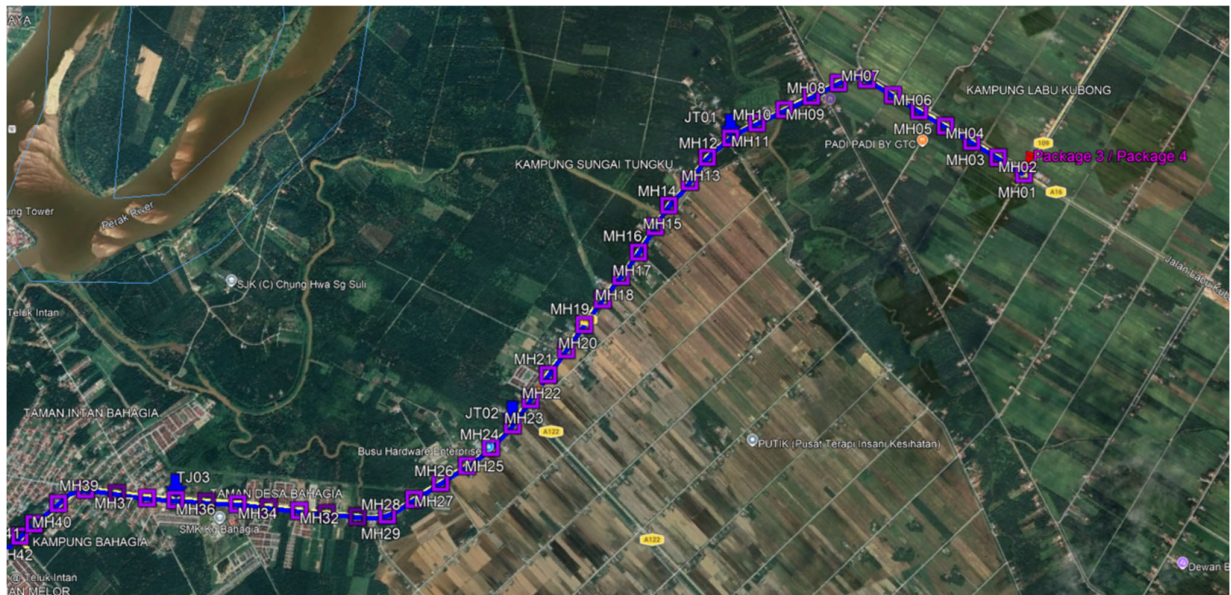

Site Plan – KMZ Routing (Manhole)

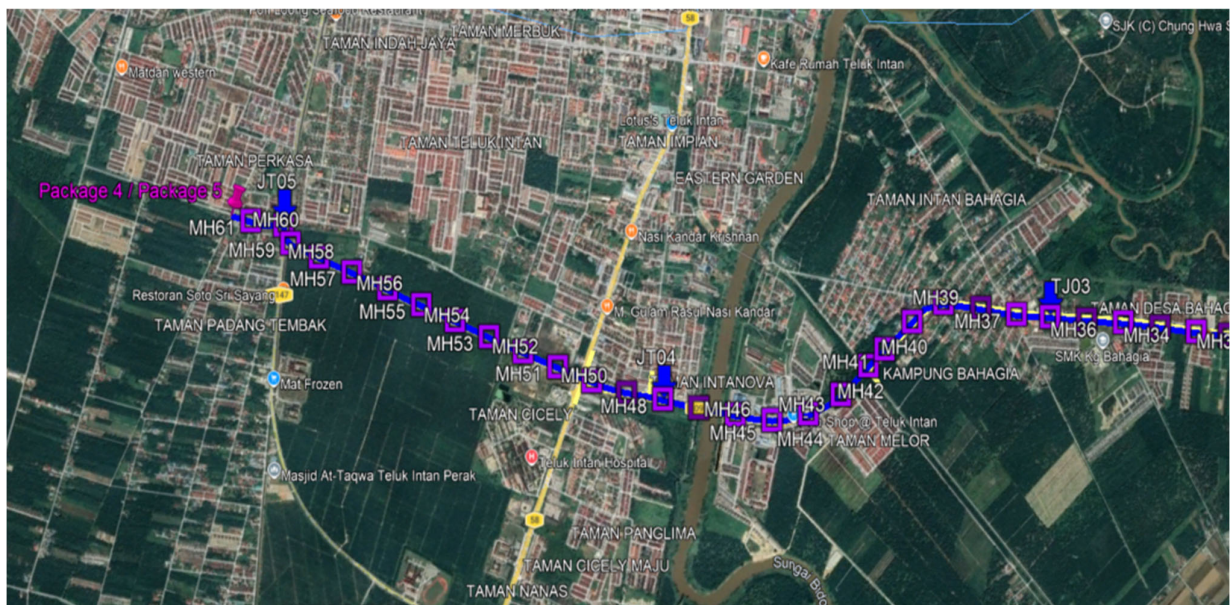

## 4.0 APPENDIX

### 4.1 Product Portfolio

TIME DOT COM CONNECTIONS FOR COMMERCIAL	
<b>Private Data Network</b>	<p>Our Virtual Private Network (VPN) is designed to deliver you an efficient, secured and reliable service. We provide point-to-point technology that directly connects you to your clients and employees. We ensure complete privacy and security, while at the same time, maximizing your speed and bandwidth;</p> <ul style="list-style-type: none"> <li>⇒ Channelized Leased Circuit</li> <li>⇒ Ethernet Leased Circuit</li> <li>⇒ International Private Leased</li> <li>⇒ Circuit (IPLC)</li> <li>⇒ Metro LAN</li> <li>⇒ International Ethernet Private Leased Circuit (IEPLC)</li> </ul>
<b>Internet</b>	<p>TIME Internet services allow you to connect to the world speedily with high scalability, reliability and security. Choose the best solution that suits your need and TIME will take care of the rest;</p> <ul style="list-style-type: none"> <li>⇒ Channelized Direct</li> <li>⇒ Ethernet Direct</li> <li>⇒ Business Broadband</li> <li>⇒ Satellite Broadband</li> <li>⇒ Home Broadband</li> </ul>
<b>Voice</b>	<p>We've got a wide range of services from basic phone line with crystal clear voice quality to our account based postpaid Virtual Call service. We also provide local and International toll free services, and even business or individual calling cards. With TIME, it's so easy to stay in touch;</p> <ul style="list-style-type: none"> <li>⇒ Business Voice Line</li> <li>⇒ ISDN PRI</li> <li>⇒ International Toll Free</li> <li>⇒ Toll Free 1300</li> <li>⇒ Toll Free 1800</li> <li>⇒ Audio Conferencing</li> <li>⇒ Home Fixed Line</li> </ul>
<b>Managed Services</b>	<p>TIME Managed Services deliver end-to-end networking solutions. Focus on your productivity while we provide you with support possible to take your business to the next level;</p> <ul style="list-style-type: none"> <li>⇒ IPVPN</li> <li>⇒ SAN Extension</li> </ul>
<b>Wholesale Service</b>	<p>We are able to offer you unmatched capacity and network resiliency. We aim to ensure seamless connectivity and high availability, thus maximizing your operational capabilities;</p> <ul style="list-style-type: none"> <li>⇒ Wholesale bandwidth</li> <li>⇒ Wholesale Voice (Transit Premium, Transit CLR)</li> <li>⇒ Cross Peninsular Cable System (CPCS)</li> </ul>

4.2 Drawing

4.2.1 Drawing – Site Plan

- REFER ATTACHMENT BELOW

### 3. Manhole Lat Long Table

MH	Total	Latitude	Longitude	Road	
<b>Package 4</b>					
	MH01	0	4.098229°	101.047804°	JALAN TELUK INTAN
MH01	MH02	240	4.097029°	101.046014°	JALAN TELUK INTAN
MH02	MH03	250	4.095783°	101.044231°	JALAN TELUK INTAN
MH03	MH04	250	4.094509°	101.042478°	JALAN TELUK INTAN
MH04	MH05	250	4.093245°	101.040732°	JALAN TELUK INTAN
MH05	MH06	250	4.091981°	101.038968°	JALAN TELUK INTAN
MH06	MH07	250	4.090723°	101.037220°	JALAN TELUK INTAN
MH07	MH08	240	4.088770°	101.036649°	JALAN TELUK INTAN
MH08	MH09	240	4.086608°	101.036773°	JALAN TELUK INTAN
MH09	MH10	240	4.084443°	101.036917°	JALAN TELUK INTAN
MH10	MH11	240	4.082266°	101.037038°	JALAN TELUK INTAN
MH11	MH12	250	4.080116°	101.037301°	JALAN TELUK INTAN
MH12	MH13	240	4.078040°	101.037929°	JALAN TELUK INTAN
MH13	MH14	240	4.076200°	101.039044°	JALAN TELUK INTAN
MH14	MH15	250	4.074169°	101.040026°	JALAN TELUK INTAN
MH15	MH16	210	4.072689°	101.041047°	JALAN TELUK INTAN
MH16	MH17	240	4.070888°	101.042266°	JALAN TELUK INTAN
MH17	MH18	240	4.069074°	101.043370°	JALAN TELUK INTAN
MH18	MH19	240	4.067240°	101.044369°	JALAN TELUK INTAN
MH19	MH20	250	4.065367°	101.045497°	JALAN TELUK INTAN
MH20	MH21	250	4.063514°	101.046633°	JALAN TELUK INTAN
MH21	MH22	240	4.061658°	101.047754°	JALAN TELUK INTAN
MH22	MH23	240	4.059851°	101.048885°	JALAN TELUK INTAN
MH23	MH24	240	4.058003°	101.050038°	JALAN TELUK INTAN
MH24	MH25	250	4.056007°	101.050898°	JALAN TELUK INTAN
MH25	MH26	240	4.053982°	101.051423°	JALAN TELUK INTAN
MH26	MH27	250	4.051829°	101.051778°	JALAN TELUK INTAN
MH27	MH28	240	4.049686°	101.052128°	JALAN TELUK INTAN
MH28	MH29	250	4.047560°	101.052398°	JALAN TELUK INTAN
MH29	MH30	235	4.045603°	101.051701°	JALAN TELUK INTAN
MH30	MH31	250	4.043709°	101.050642°	JALAN TELUK INTAN
MH31	MH32	215	4.042027°	101.049734°	JALAN TELUK INTAN
MH32	MH33	240	4.040147°	101.048675°	JALAN TELUK INTAN
MH33	MH34	240	4.038246°	101.047612°	JALAN TELUK INTAN
MH34	MH35	240	4.036296°	101.046641°	JALAN TELUK INTAN
MH35	MH36	240	4.034365°	101.045656°	JALAN TELUK INTAN
MH36	MH37	230	4.032579°	101.044766°	JALAN TELUK INTAN
MH37	MH38	240	4.030766°	101.043639°	JALAN TELUK INTAN
MH38	MH39	250	4.028829°	101.042540°	JALAN TELUK INTAN
MH39	MH40	250	4.026742°	101.042696°	JALAN TELUK INTAN
MH40	MH41	240	4.024675°	101.043345°	JALAN TELUK INTAN
MH41	MH42	150	4.023462°	101.043757°	JALAN TELUK INTAN
MH42	MH43	250	4.021376°	101.044469°	JALAN TELUK INTAN
MH43	MH44	250	4.019221°	101.044623°	JALAN TELUK INTAN
MH44	MH45	240	4.017120°	101.044081°	JALAN TELUK INTAN
MH45	MH46	250	4.015226°	101.042984°	JALAN TELUK INTAN
MH46	MH47	250	4.013383°	101.041813°	JALAN TELUK INTAN
MH47	MH48	250	4.011602°	101.040574°	JALAN TELUK INTAN
MH48	MH49	250	4.009753°	101.039443°	JALAN TELUK INTAN
MH49	MH50	240	4.008099°	101.038082°	JALAN TELUK INTAN
MH50	MH51	250	4.006514°	101.036622°	PINTASAN LHDN HILIR PERAK
MH51	MH52	240	4.004918°	101.035108°	PINTASAN LHDN HILIR PERAK
MH52	MH53	250	4.003360°	101.033602°	PINTASAN LHDN HILIR PERAK
MH53	MH54	250	4.001812°	101.032047°	PINTASAN LHDN HILIR PERAK
MH54	MH55	240	4.000289°	101.030514°	PINTASAN LHDN HILIR PERAK
MH55	MH56	250	3.998741°	101.028963°	PINTASAN LHDN HILIR PERAK
MH56	MH57	250	3.997125°	101.027341°	PINTASAN LHDN HILIR PERAK
MH57	MH58	240	3.995610°	101.025858°	PINTASAN LHDN HILIR PERAK
MH58	MH59	210	3.994330°	101.024532°	PINTASAN LHDN HILIR PERAK
MH59	MH60	120	3.994294°	101.023507°	PERSIRAN JALAN BANJAR
MH60	MH61	230	3.992581°	101.022525°	PERSIRAN JALAN BANJAR
MH61	MH01	140	3.991616°	101.021798°	PERSIRAN JALAN BANJAR











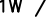



KELULUSAN PLAN


Local Authorities:-

CONFIDENTIALITY

These drawings and details are and shall remain the property of TT dotCom Sdn Bhd. Both are issued in strict confidence and shall not be reproduced, copied or used in any manner without specific written permission from the owner.

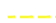LEGEND :- OUTSIDE PLANT

-  = BUILDING MANHOLE
-  = BUILDING PIT
-  = PROPOSED TIME MANHOLE
-  = EXISTING TIME MANHOLE
-  = PROPOSED TIME DUCT ROUTE
-  = PROPOSED TIME DUCT TO BUILDING
-  = EXISTING BUILDING DUCT ROUTE
-  = EXISTING BUILDING CABLE TRAY
-  = PROPOSED TRUNKING
-  = PROPOSED CONDUIT
-  = CLAIM AREA
- 1W / 2W = 1 WAY OR 2 WAY DUCT
- GI = GALVANISED IRON DUCT
- PVC = PVC DUCT
-  = HIDDEN DRAIN
-  = VISIBLE DRAIN
-  = TREES AND PLANTS

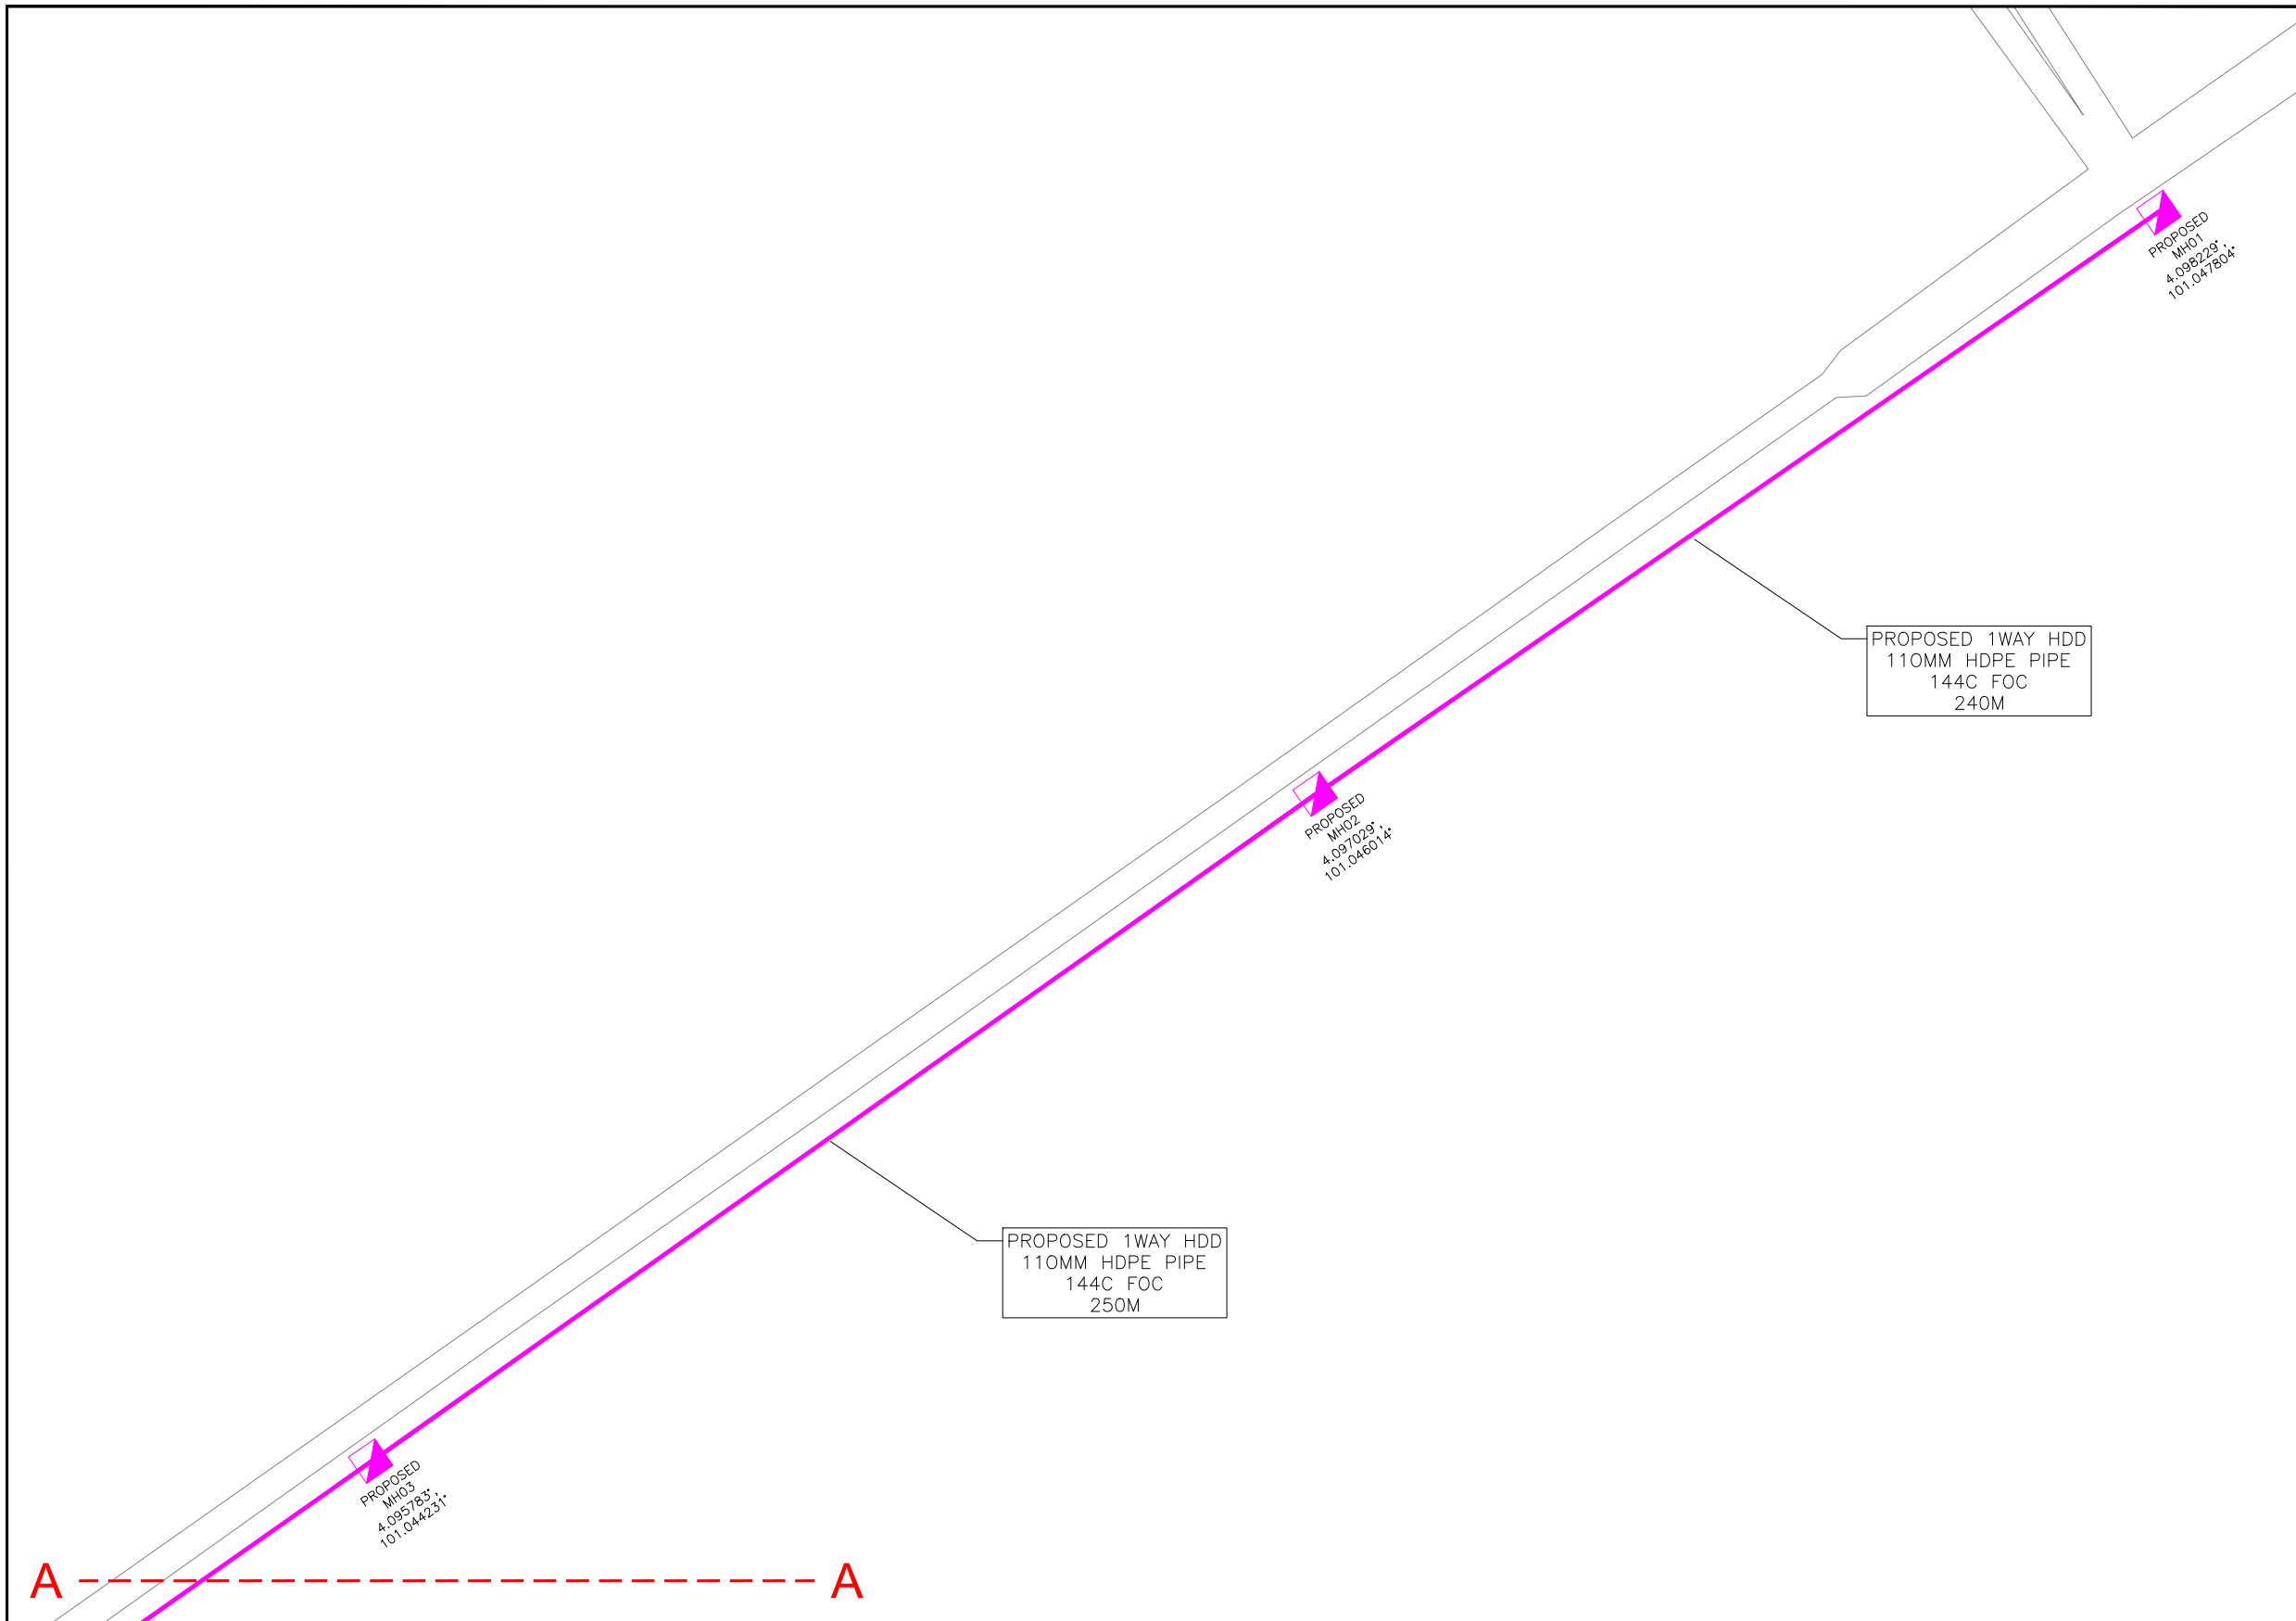


REV. NO.	REV. DATE	REV. BY	DESCRIPTION:



TT dotCom Sdn Bhd (52371-A)  
No 14, Jalan Majistret U1/26,  
Hicom Glenmarie Industrial Park  
40150 Shah Alam, Selangor Darul Ehsan, Malaysia.  
Tel: +60 3 5032 6000  
Website: www.time.com.my

PROJECT TITLE: FTK NEW 1W UNDERGROUND CIVIL & 1X144F CABLE PULLING INFRASTRUCTURE FROM BIDOR – H.MELINTANG (PACKAGE 4)	
DRAWING TITLE: PROPOSED DRAWING (PREVENTIVE MAINTENANCE WITH ANTI RODENT 144C FIBER)	
DRAWING NO: TTdC/0000/UMOB/LEML/0001	SHEET NO: 31 OF 1

DRAWING SCALE: N.T.S	DRAWING UNITS: METER
PREPARED BY: AMTEL RESOURCES SDN BHD	INITIAL & DATE: -
DESIGNED BY: JEMI	INITIAL & DATE: -
CHECKED BY: FAZWAN	INITIAL & DATE: -
APPROVED BY: -	INITIAL & DATE: -

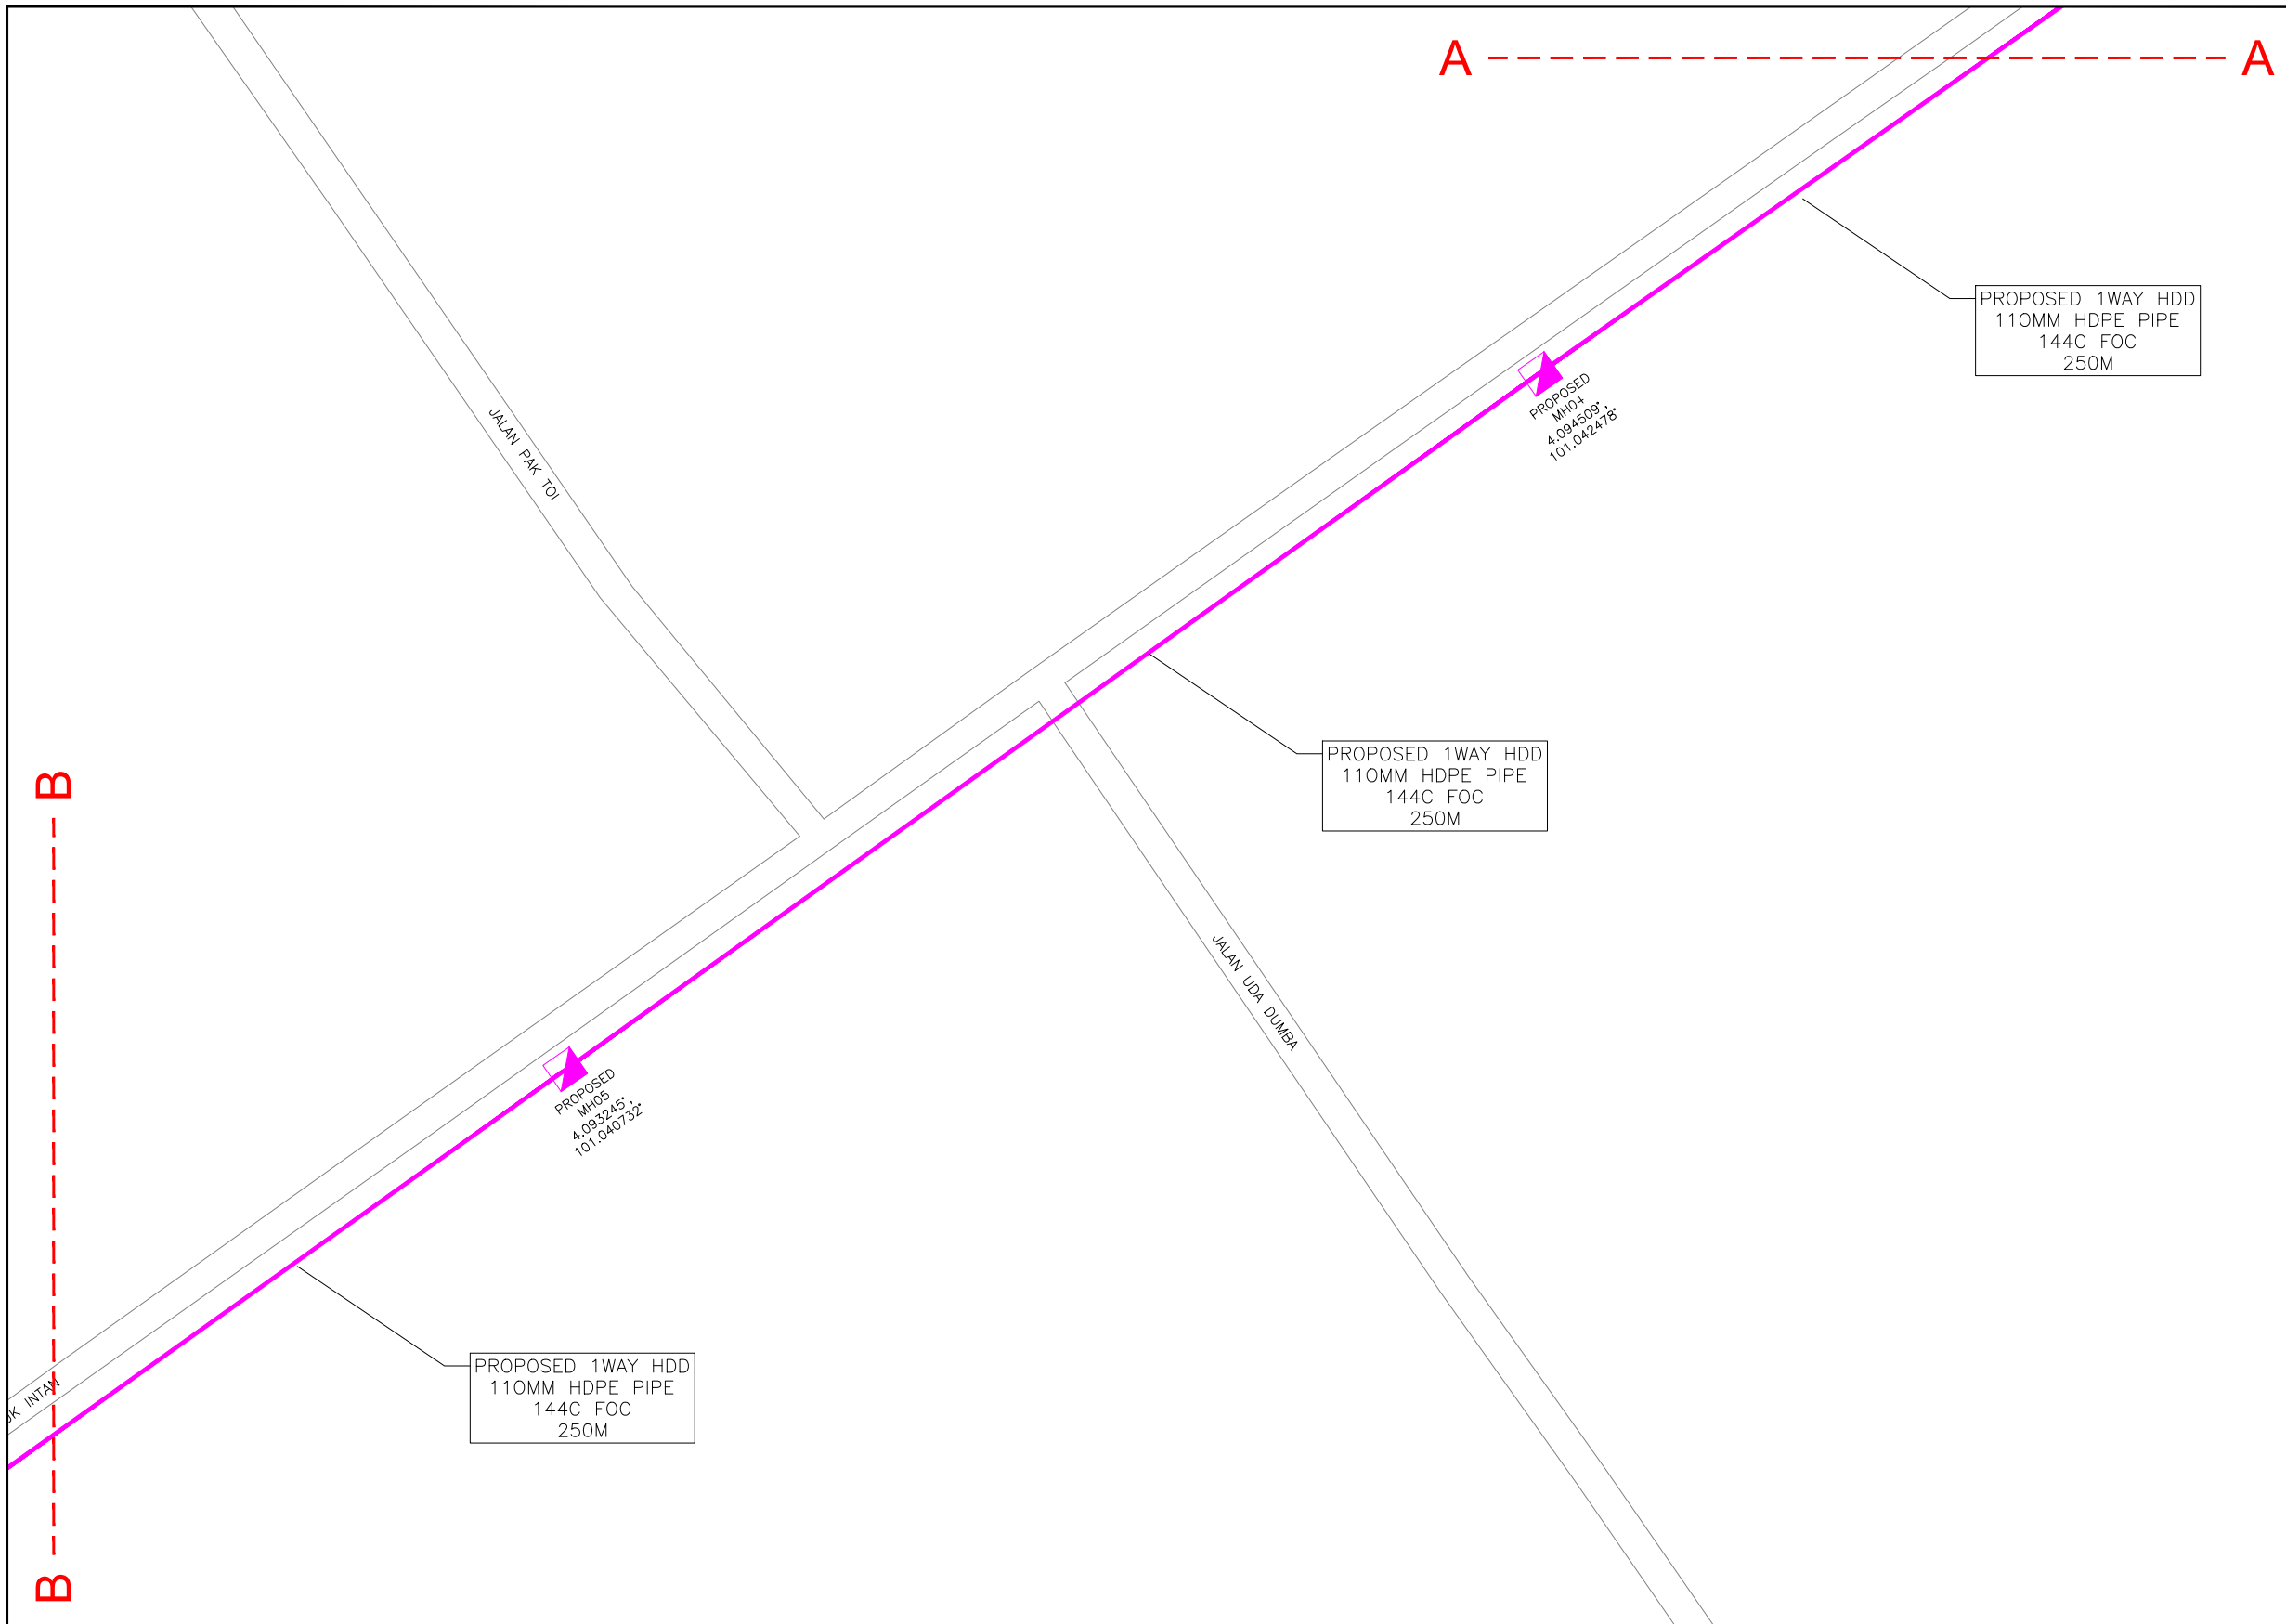

KELULUSAN PLAN

Local Authorities:-

CONFIDENTIALITY

These drawings and details are and shall remain the property of TT dotCom Sdn Bhd. Both are issued in strict confidence and shall not be reproduced, copied or used in any manner without specific written permission from the owner.

LEGEND :- OUTSIDE PLANT

- = BUILDING MANHOLE
- = BUILDING PIT
- = PROPOSED TIME MANHOLE
- = EXISTING TIME MANHOLE
- = PROPOSED TIME DUCT ROUTE
- = PROPOSED TIME DUCT TO BUILDING
- = EXISTING BUILDING DUCT ROUTE
- = EXISTING BUILDING CABLE TRAY
- = PROPOSED TRUNKING
- = PROPOSED CONDUIT
- = CLAIM AREA
- 1W / 2W = 1 WAY OR 2 WAY DUCT
- GI = GALVANISED IRON DUCT
- PVC = PVC DUCT
- = HIDDEN DRAIN
- = VISIBLE DRAIN
- = TREES AND PLANTS

REV. NO.	REV. DATE	REV. BY	DESCRIPTION:




TT dotCom Sdn Bhd (52371-A)  
 No 14, Jalan Majistret U1/26,  
 Hicom Glenmarie Industrial Park  
 40150 Shah Alam, Selangor Darul Ehsan, Malaysia.  
 Tel: +60 3 5032 6000  
 Website: www.time.com.my

PROJECT TITLE:  
 FTK NEW 1W UNDERGROUND CIVIL & 1X144F CABLE  
 PULLING INFRASTRUCTURE FROM  
 BIDOR – H.MELINTANG (PACKAGE 4)

DRAWING TITLE:  
 PROPOSED DRAWING  
 (PREVENTIVE MAINTENANCE WITH ANTI RODENT  
 144C FIBER)

DRAWING NO: TTdC/0000/UMOB/LEML/0001      SHEET NO: 31 OF 2

DRAWING SCALE: N.T.S	DRAWING UNITS: METER
PREPARED BY: AMTEL RESOURCES SDN BHD	INITIAL & DATE: -
DESIGNED BY: JEMI	INITIAL & DATE: -
CHECKED BY: FAZWAN	INITIAL & DATE: -
APPROVED BY: -	INITIAL & DATE: -

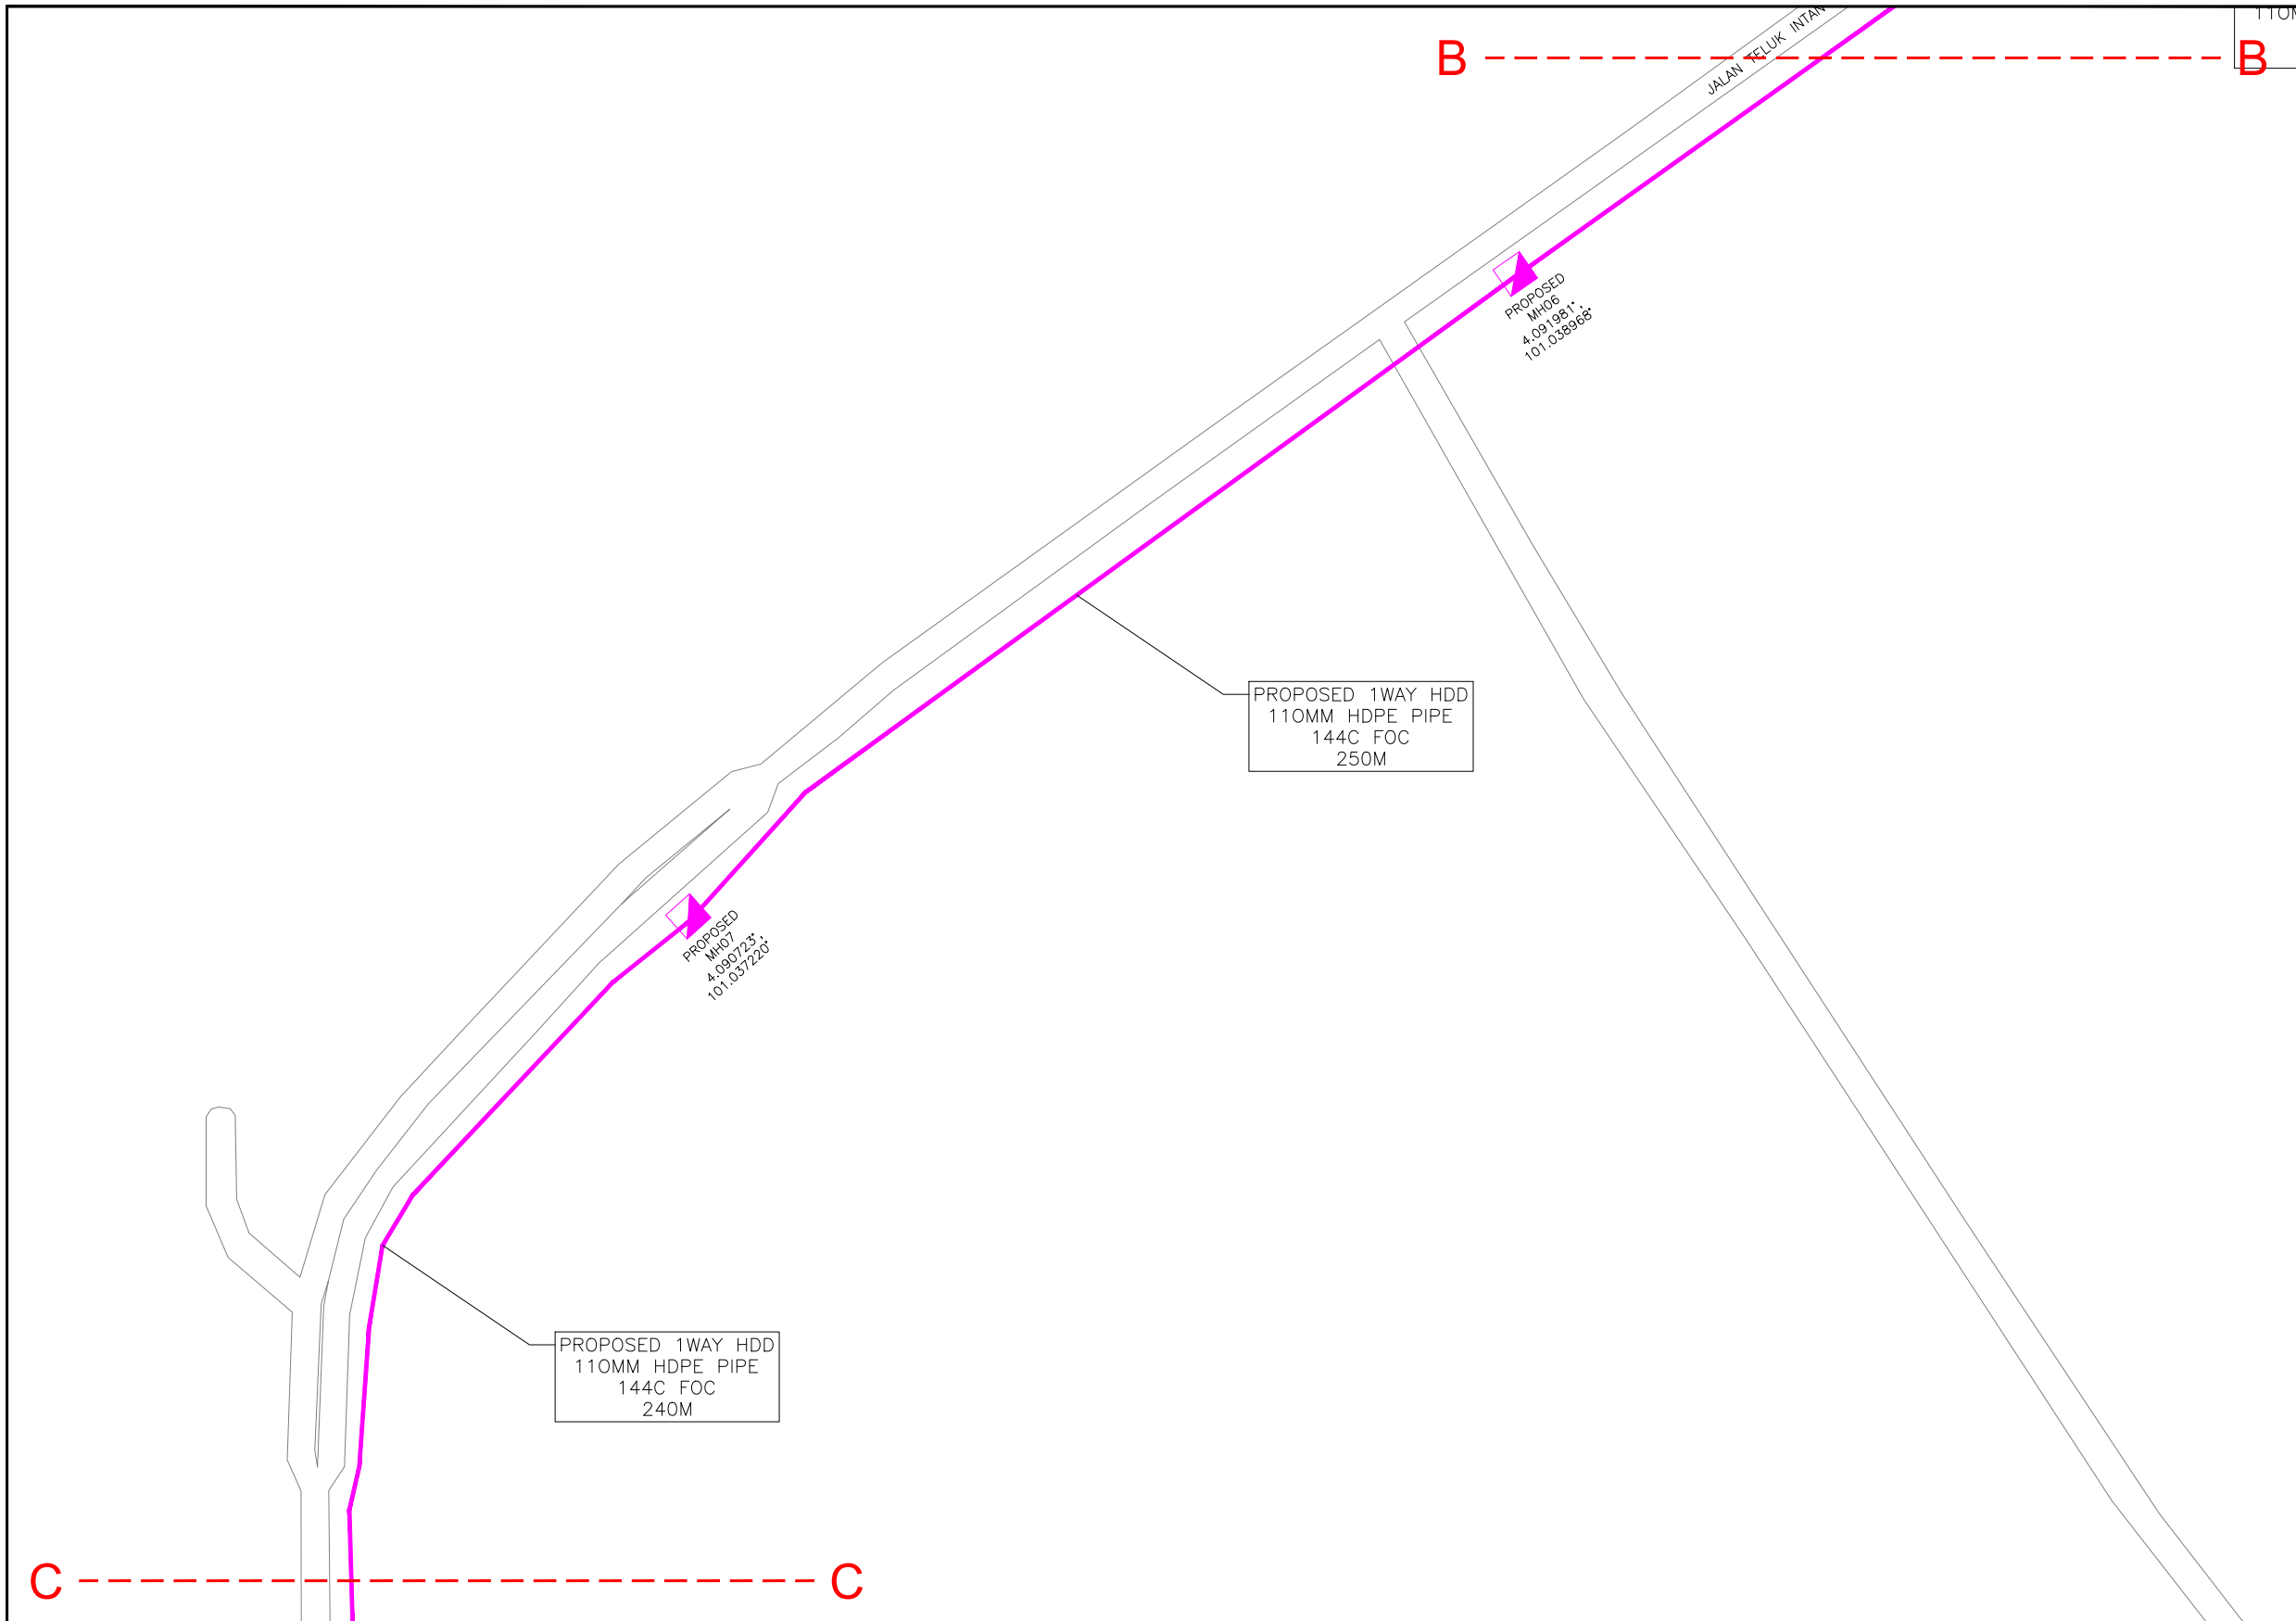

Local Authorities:-

CONFIDENTIALITY

These drawings and details are and shall remain the property of TT dotCom Sdn Bhd. Both are issued in strict confidence and shall not be reproduced, copied or used in any manner without specific written permission from the owner.

- LEGEND :- OUTSIDE PLANT**
- = BUILDING MANHOLE
  - = BUILDING PIT
  - = PROPOSED TIME MANHOLE
  - = EXISTING TIME MANHOLE
  - = PROPOSED TIME DUCT ROUTE
  - = PROPOSED TIME DUCT TO BUILDING
  - = EXISTING BUILDING DUCT ROUTE
  - = EXISTING BUILDING CABLE TRAY
  - = PROPOSED TRUNKING
  - = PROPOSED CONDUIT
  - = CLAIM AREA
  - 1W / 2W = 1 WAY OR 2 WAY DUCT
  - GI = GALVANISED IRON DUCT
  - PVC = PVC DUCT
  - = HIDDEN DRAIN
  - = VISIBLE DRAIN
  - = TREES AND PLANTS


REV. NO.	REV. DATE	REV. BY	DESCRIPTION:



TT dotCom Sdn Bhd (52371-A)  
No 14, Jalan Majistret U1/26,  
Hicom Glenmarie Industrial Park  
40150 Shah Alam, Selangor Darul Ehsan, Malaysia.  
Tel: +60 3 5032 6000  
Website: www.time.com.my

PROJECT TITLE: FTK NEW 1W UNDERGROUND CIVIL & 1X144F CABLE PULLING INFRASTRUCTURE FROM BIDOR – H.MELINTANG (PACKAGE 4)	
DRAWING TITLE: PROPOSED DRAWING (PREVENTIVE MAINTENANCE WITH ANTI RODENT 144C FIBER)	
DRAWING NO: TTdC/0000/UMOB/LEML/0001	SHEET NO: 31 OF 3

DRAWING SCALE: N.T.S	DRAWING UNITS: METER
PREPARED BY: AMTEL RESOURCES SDN BHD	INITIAL & DATE: -
DESIGNED BY: JEMI	INITIAL & DATE: -
CHECKED BY: FAZWAN	INITIAL & DATE: -
APPROVED BY: -	INITIAL & DATE: -

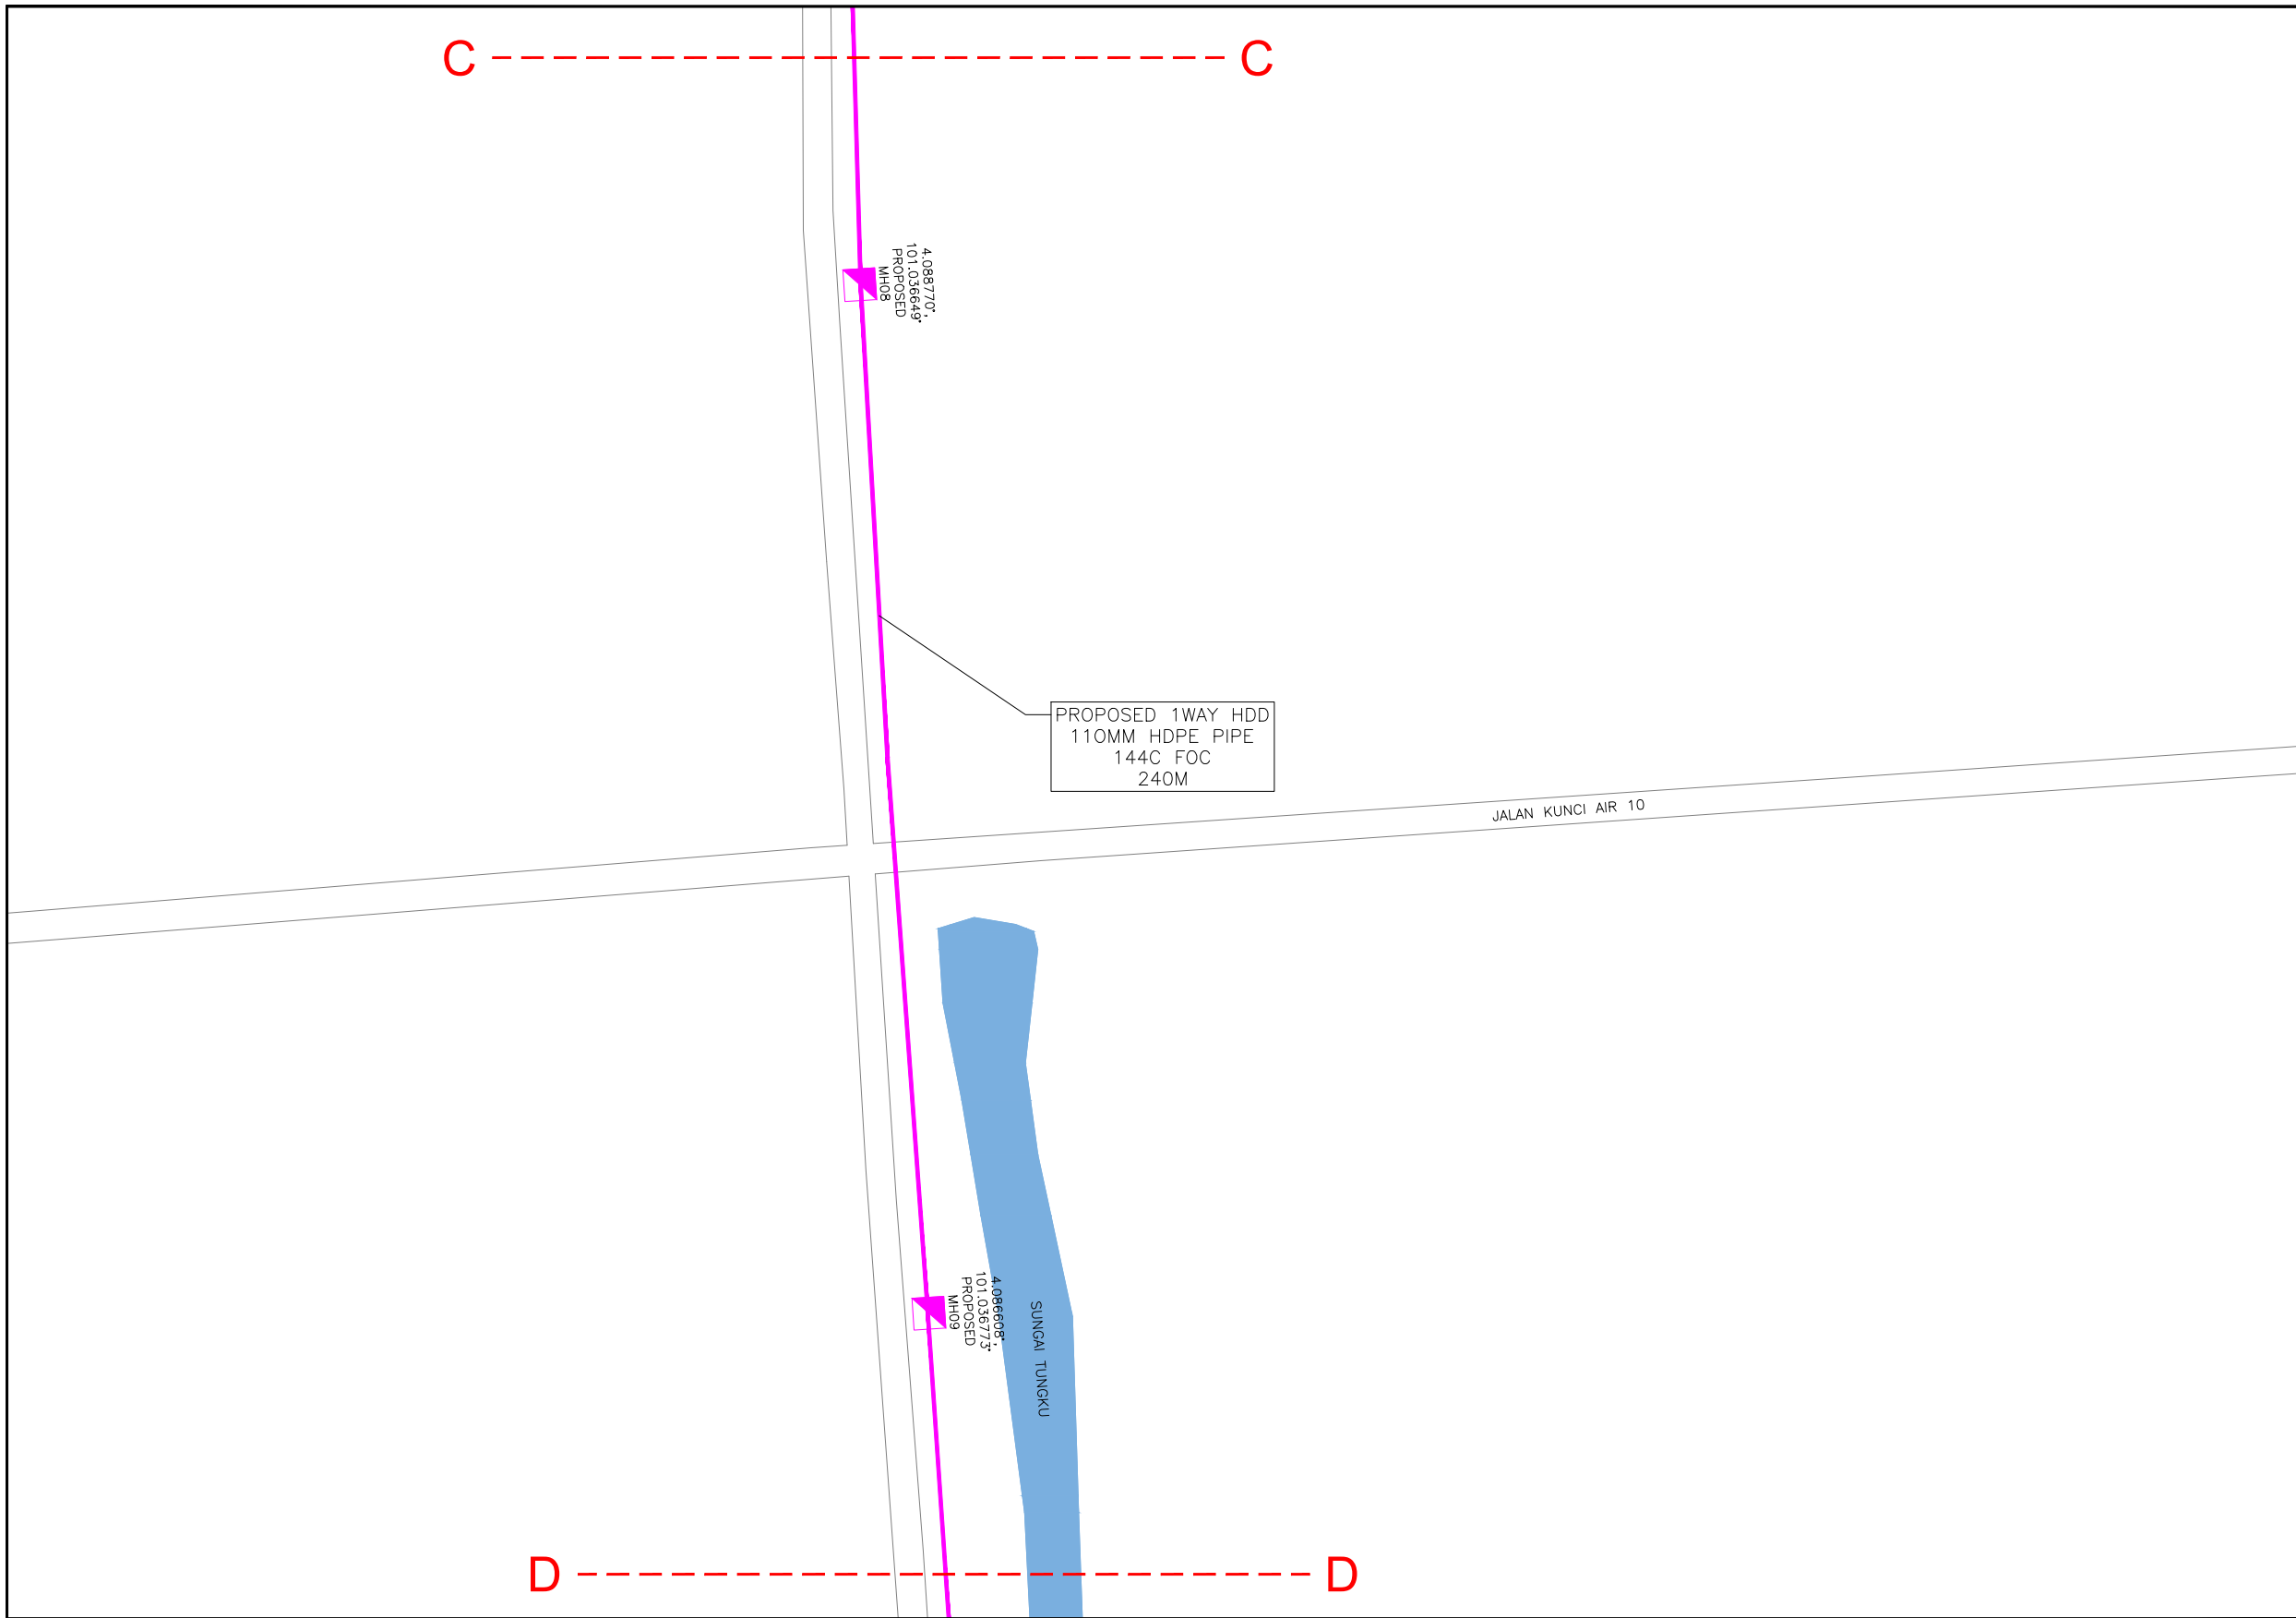

KELULUSAN PLAN

Local Authorities:--

CONFIDENTIALITY

These drawings and details are and shall remain the property of TT dotCom Sdn Bhd. Both are issued in strict confidence and shall not be reproduced, copied or used in any manner without specific written permission from the owner.

LEGEND :- OUTSIDE PLANT

- = BUILDING MANHOLE
- = BUILDING PIT
- = PROPOSED TIME MANHOLE
- = EXISTING TIME MANHOLE
- = PROPOSED TIME DUCT ROUTE
- = PROPOSED TIME DUCT TO BUILDING
- = EXISTING BUILDING DUCT ROUTE
- = EXISTING BUILDING CABLE TRAY
- = PROPOSED TRUNKING
- = PROPOSED CONDUIT
- = CLAIM AREA
- 1W / 2W = 1 WAY OR 2 WAY DUCT
- GI = GALVANISED IRON DUCT
- PVC = PVC DUCT
- = HIDDEN DRAIN
- = VISIBLE DRAIN
- = TREES AND PLANTS

REV. NO.	REV. DATE	REV. BY	DESCRIPTION:




TT dotCom Sdn Bhd (52371-A)  
 No 14, Jalan Majistret U1/26,  
 Hicom Glenmarie Industrial Park  
 40150 Shah Alam, Selangor Darul Ehsan, Malaysia.  
 Tel: +60 3 5032 6000  
 Website: www.time.com.my

PROJECT TITLE:  
 FTK NEW 1W UNDERGROUND CIVIL & 1X144F CABLE  
 PULLING INFRASTRUCTURE FROM  
 BIDOR – H.MELINTANG (PACKAGE 4)

DRAWING TITLE:  
 PROPOSED DRAWING  
 (PREVENTIVE MAINTENANCE WITH ANTI RODENT  
 144C FIBER)

DRAWING NO: TTdC/0000/UMOB/LEML/0001      SHEET NO: 31 OF 4

DRAWING SCALE: N.T.S	DRAWING UNITS: METER
PREPARED BY: AMTEL RESOURCES SDN BHD	INITIAL & DATE: -
DESIGNED BY: JEMI	INITIAL & DATE: -
CHECKED BY: FAZWAN	INITIAL & DATE: -
APPROVED BY: -	INITIAL & DATE: -

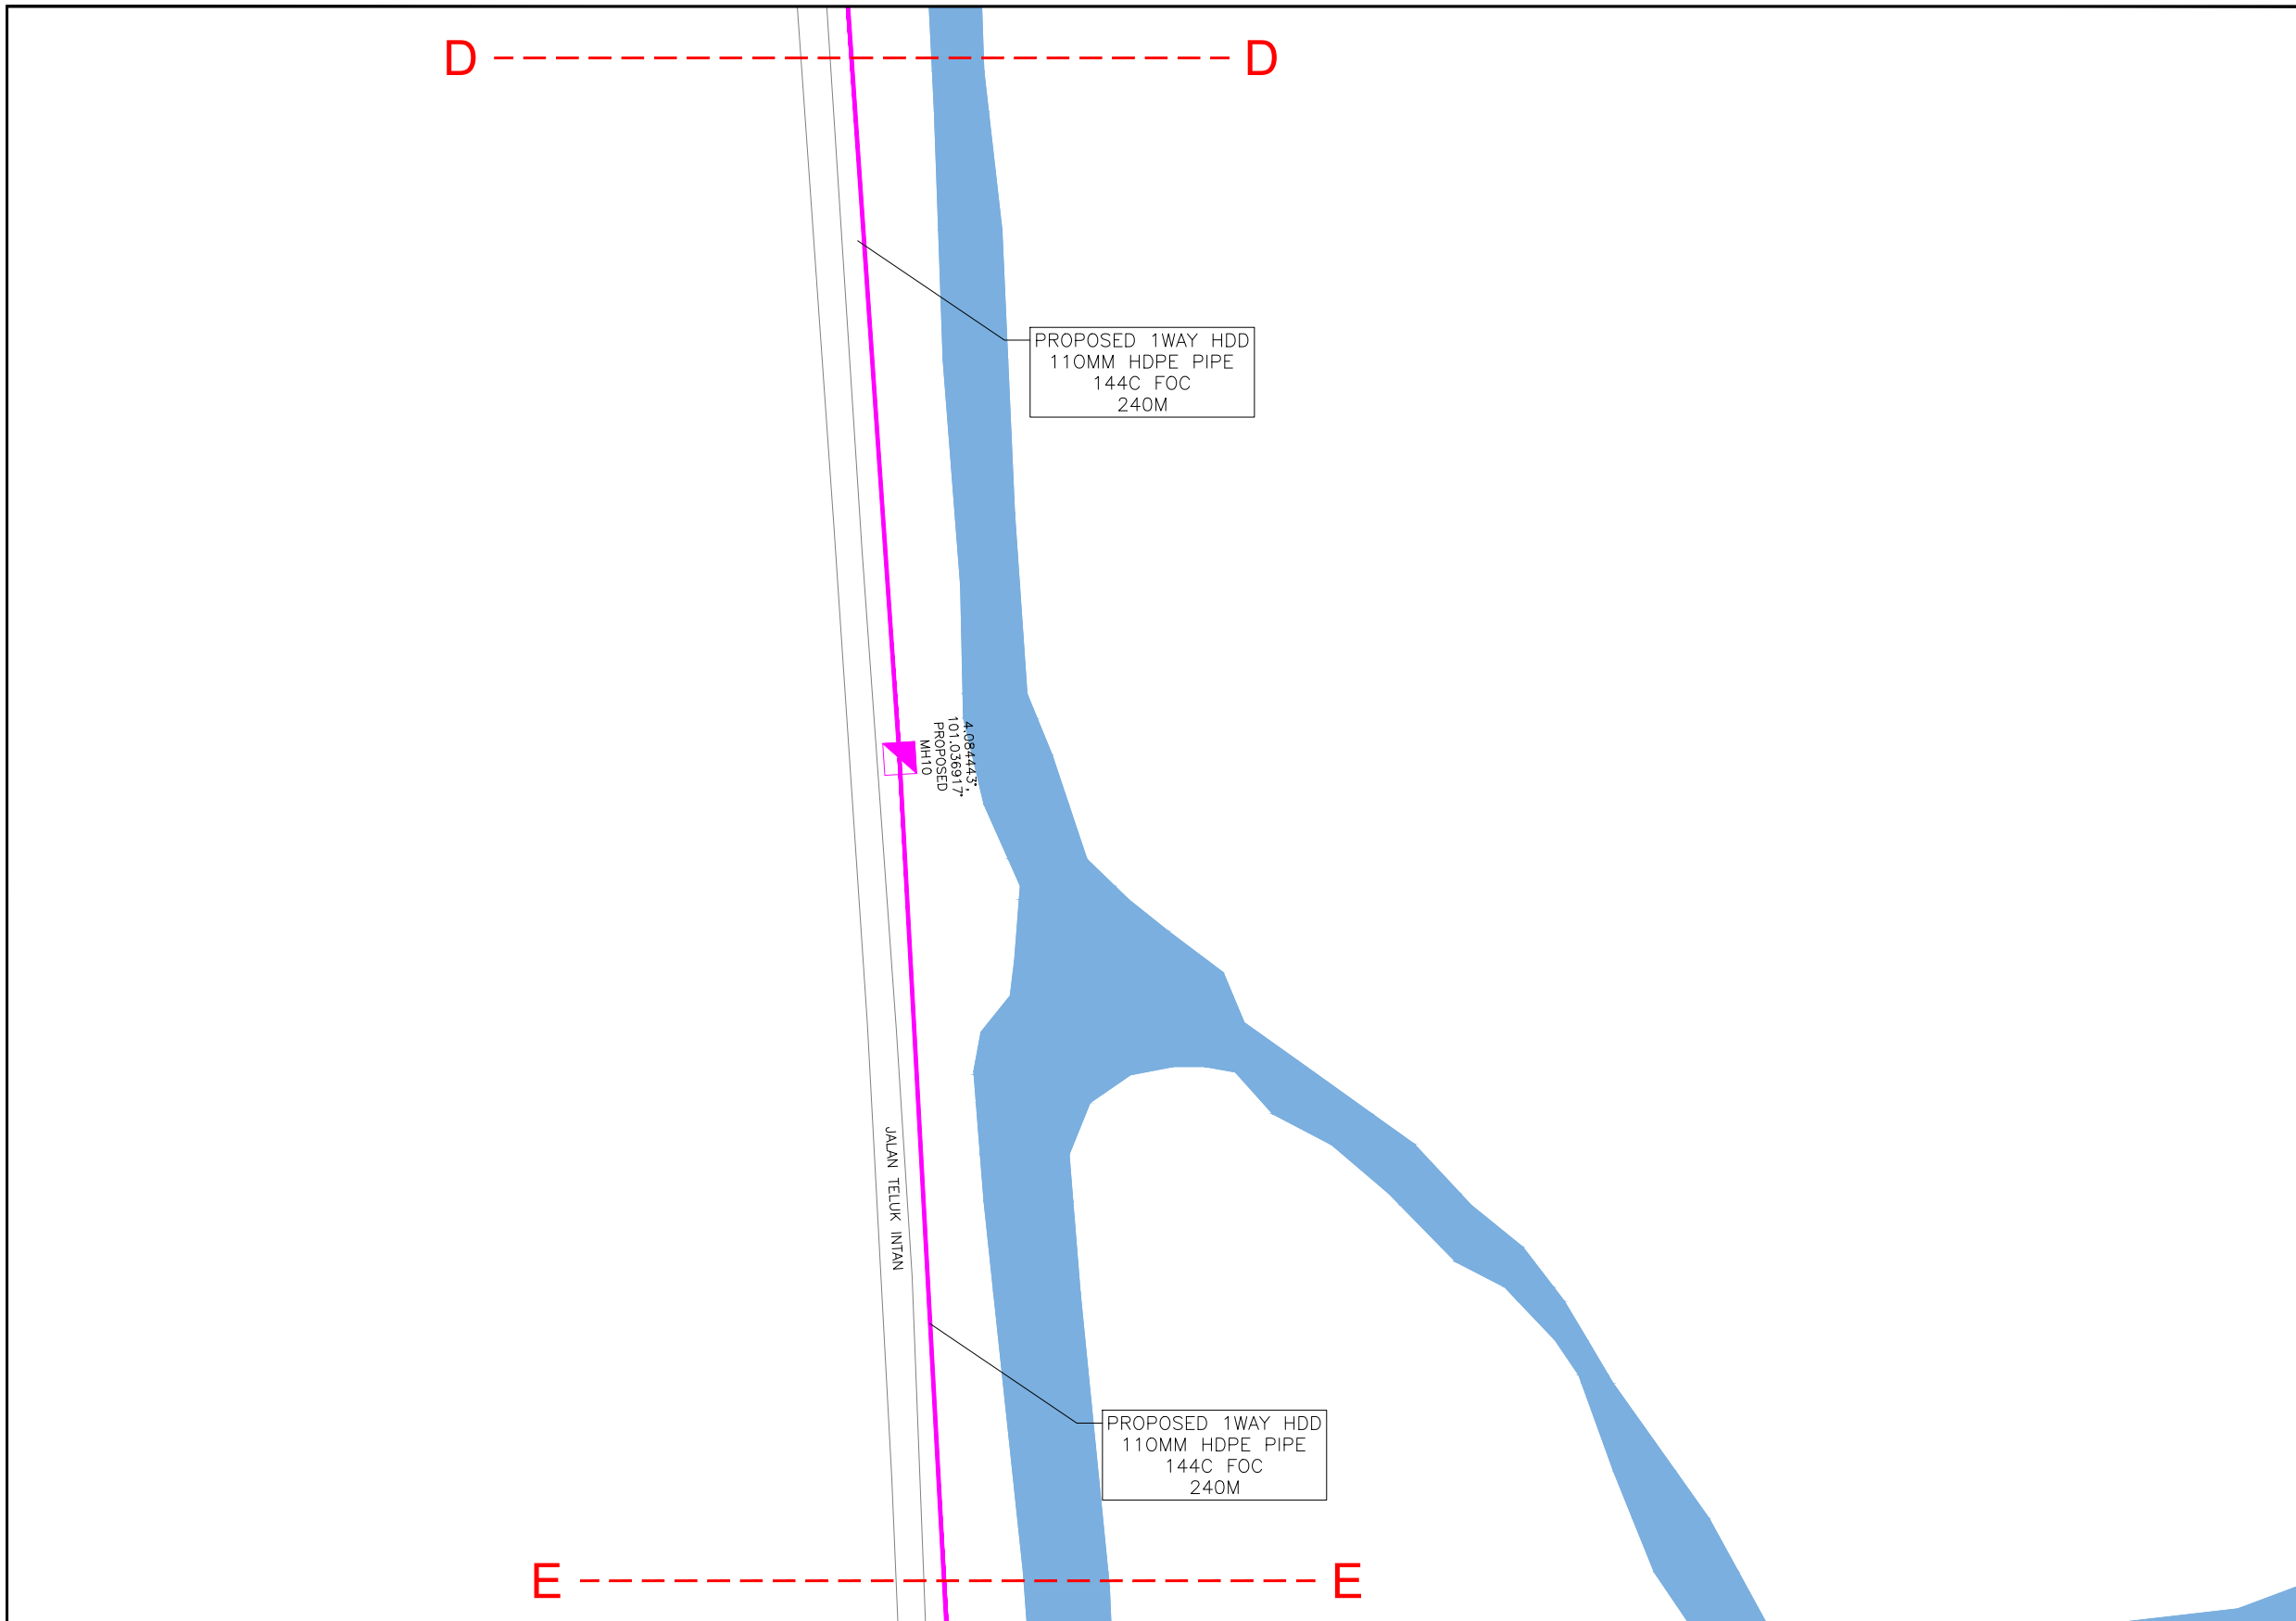

KELULUSAN PLAN

Local Authorities:-

CONFIDENTIALITY

These drawings and details are and shall remain the property of TT dotCom Sdn Bhd. Both are issued in strict confidence and shall not be reproduced, copied or used in any manner without specific written permission from the owner.

LEGEND :- OUTSIDE PLANT

- = BUILDING MANHOLE
- = BUILDING PIT
- = PROPOSED TIME MANHOLE
- = EXISTING TIME MANHOLE
- = PROPOSED TIME DUCT ROUTE
- = PROPOSED TIME DUCT TO BUILDING
- = EXISTING BUILDING DUCT ROUTE
- = EXISTING BUILDING CABLE TRAY
- = PROPOSED TRUNKING
- = PROPOSED CONDUIT
- = CLAIM AREA
- 1W / 2W = 1 WAY OR 2 WAY DUCT
- GI = GALVANISED IRON DUCT
- PVC = PVC DUCT
- = HIDDEN DRAIN
- = VISIBLE DRAIN
- = TREES AND PLANTS


REV. NO.	REV. DATE	REV. BY	DESCRIPTION:



TT dotCom Sdn Bhd (52371-A)  
 No 14, Jalan Majistret U1/26,  
 Hicom Glenmarie Industrial Park  
 40150 Shah Alam, Selangor Darul Ehsan, Malaysia.  
 Tel: +60 3 5032 6000  
 Website: www.time.com.my

PROJECT TITLE: FTK NEW 1W UNDERGROUND CIVIL & 1X144F CABLE PULLING INFRASTRUCTURE FROM BIDOR – H.MELINTANG (PACKAGE 4)	
DRAWING TITLE: PROPOSED DRAWING (PREVENTIVE MAINTENANCE WITH ANTI RODENT 144C FIBER)	
DRAWING NO: TTdC/0000/UMOB/LEML/0001	SHEET NO: 31 OF 5

DRAWING SCALE: N.T.S	DRAWING UNITS: METER
PREPARED BY: AMTEL RESOURCES SDN BHD	INITIAL & DATE: -
DESIGNED BY: JEMI	INITIAL & DATE: -
CHECKED BY: FAZWAN	INITIAL & DATE: -
APPROVED BY: -	INITIAL & DATE: -

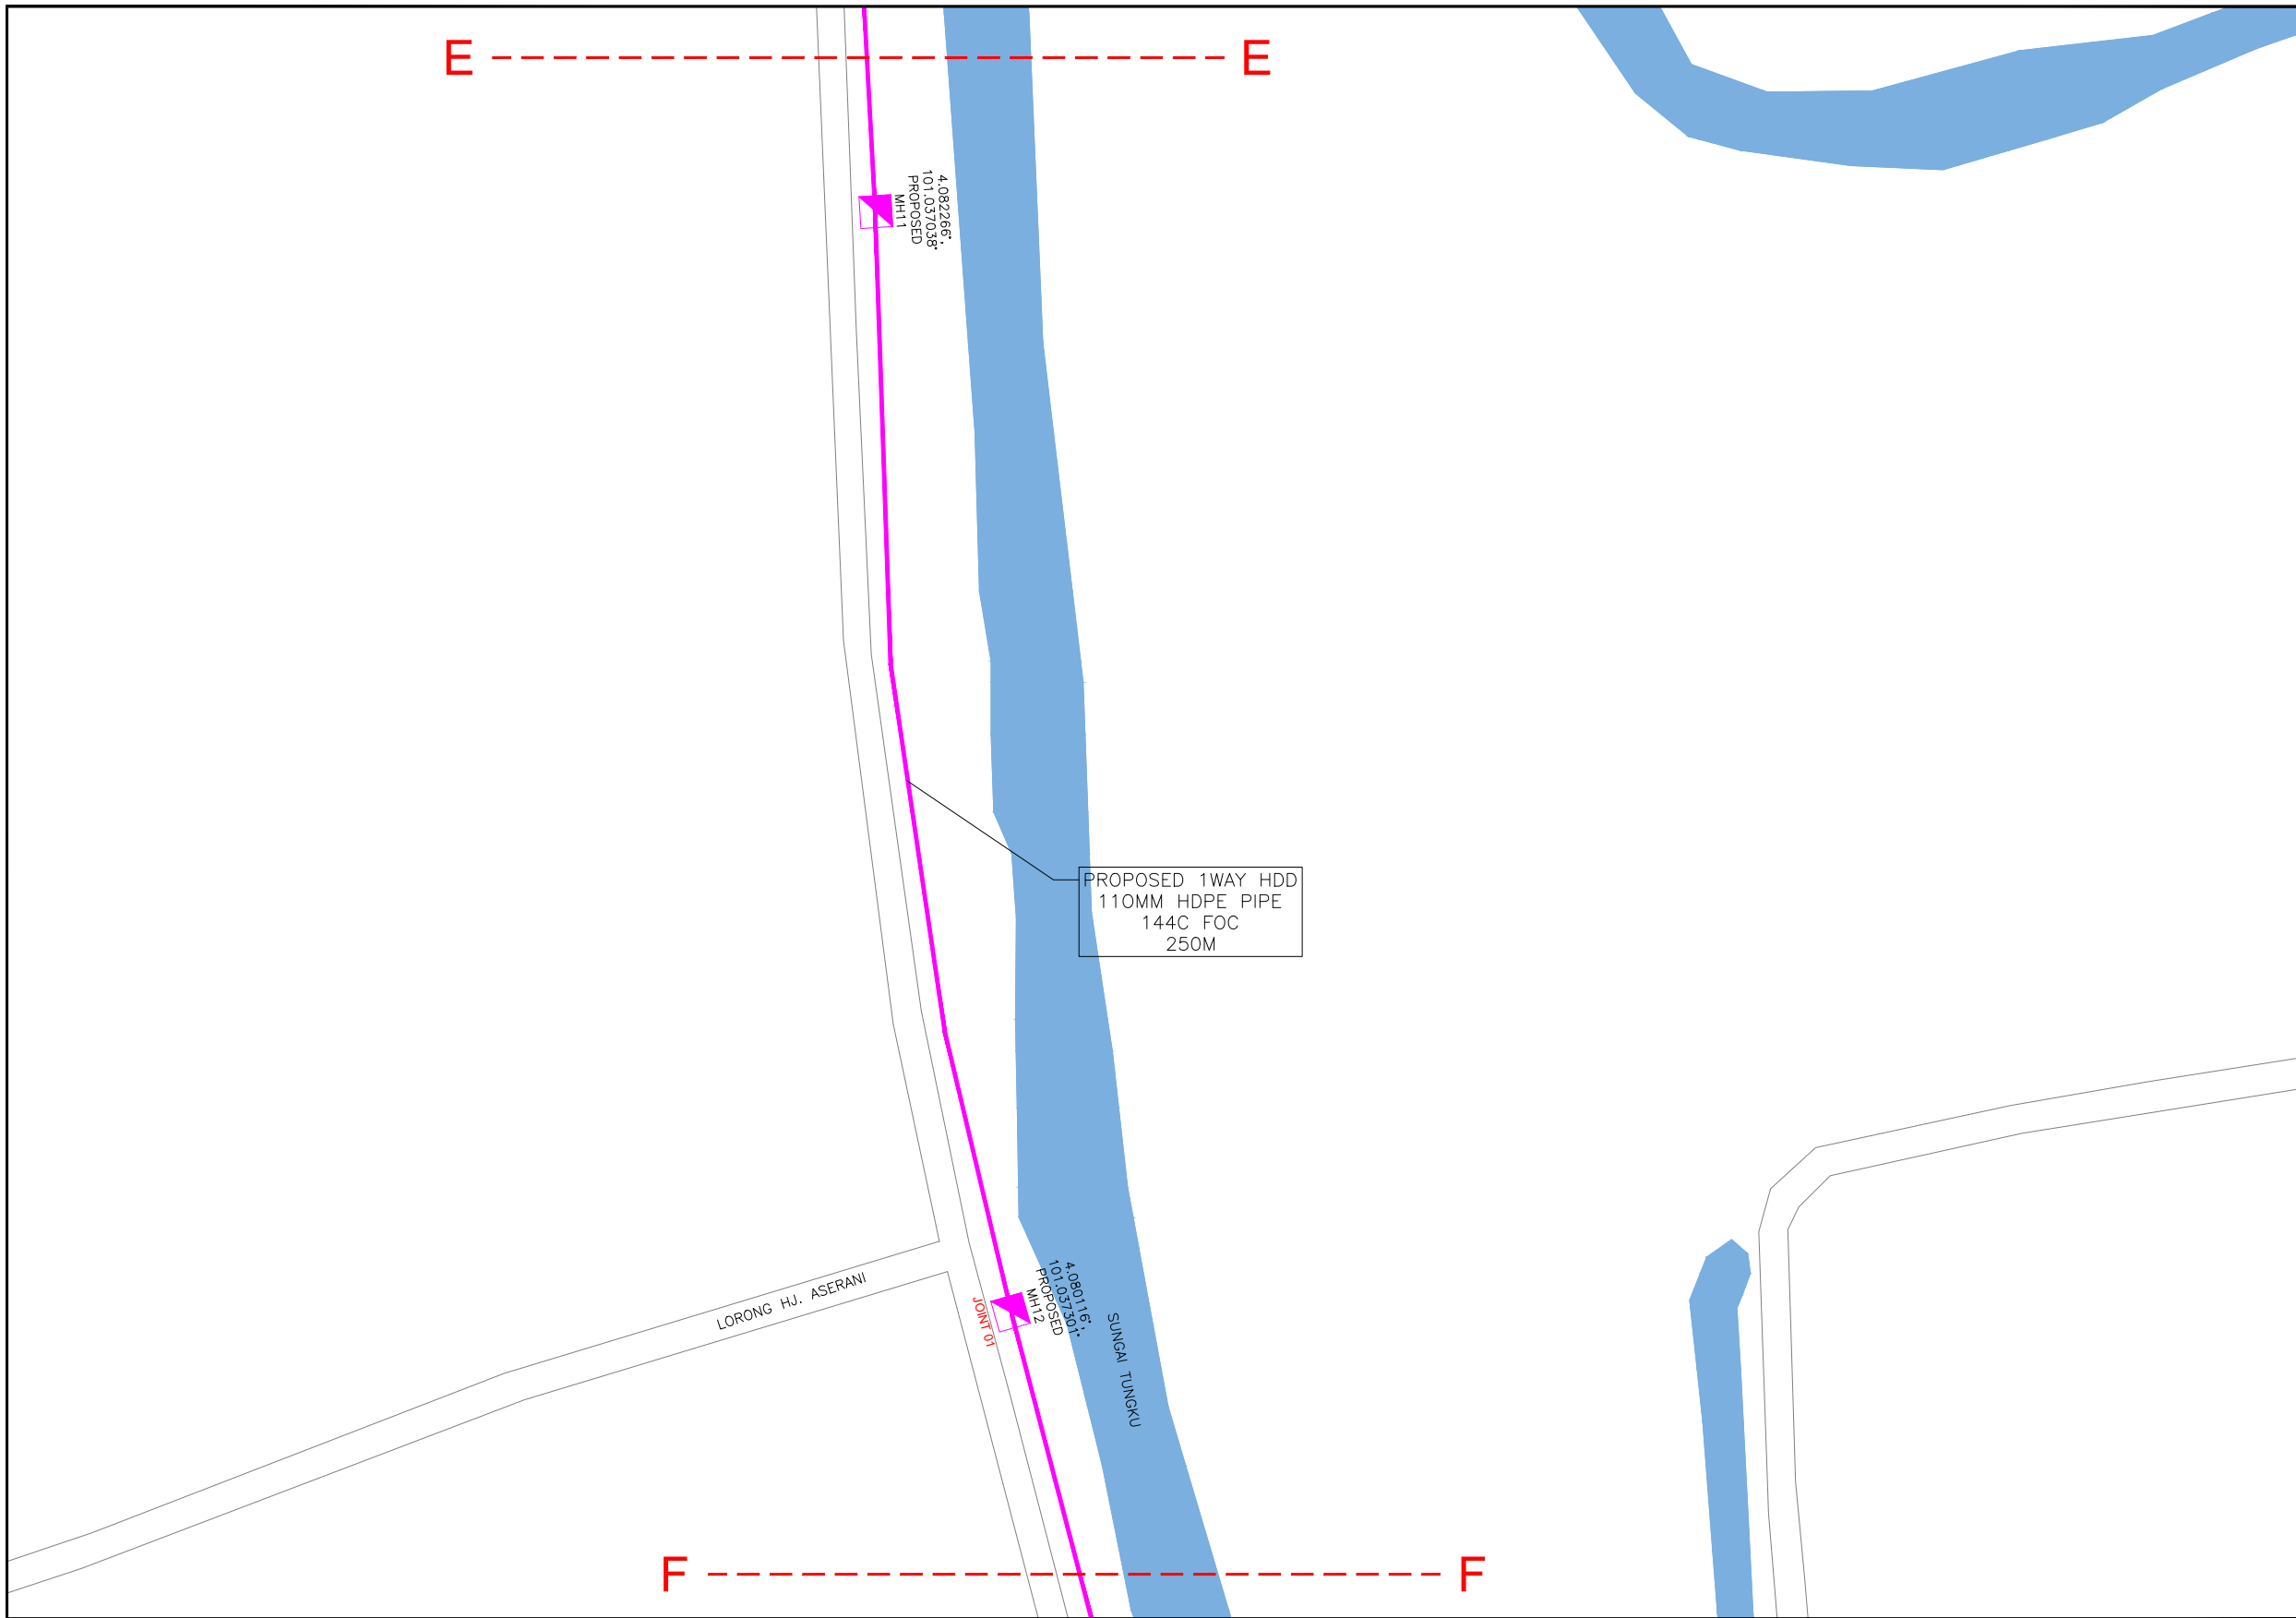

KELULUSAN PLAN

Local Authorities:-

CONFIDENTIALITY

These drawings and details are and shall remain the property of TT dotCom Sdn Bhd. Both are issued in strict confidence and shall not be reproduced, copied or used in any manner without specific written permission from the owner.

LEGEND :- OUTSIDE PLANT

- = BUILDING MANHOLE
- = BUILDING PIT
- = PROPOSED TIME MANHOLE
- = EXISTING TIME MANHOLE
- = PROPOSED TIME DUCT ROUTE
- = PROPOSED TIME DUCT TO BUILDING
- = EXISTING BUILDING DUCT ROUTE
- = EXISTING BUILDING CABLE TRAY
- = PROPOSED TRUNKING
- = PROPOSED CONDUIT
- = CLAIM AREA
- 1W / 2W = 1 WAY OR 2 WAY DUCT
- GI = GALVANISED IRON DUCT
- PVC = PVC DUCT
- = HIDDEN DRAIN
- = VISIBLE DRAIN
- = TREES AND PLANTS


REV. NO.	REV. DATE	REV. BY	DESCRIPTION:



TT dotCom Sdn Bhd (52371-A)  
 No 14, Jalan Majistret U1/26,  
 Hicom Glenmarie Industrial Park  
 40150 Shah Alam, Selangor Darul Ehsan, Malaysia.  
 Tel: +60 3 5032 6000  
 Website: www.time.com.my

PROJECT TITLE: FTK NEW 1W UNDERGROUND CIVIL & 1X144F CABLE PULLING INFRASTRUCTURE FROM BIDOR – H.MELINTANG (PACKAGE 4)	
DRAWING TITLE: PROPOSED DRAWING (PREVENTIVE MAINTENANCE WITH ANTI RODENT 144C FIBER)	
DRAWING NO: TTdC/0000/UMOB/LEML/0001	SHEET NO: 31 OF 6

DRAWING SCALE: N.T.S	DRAWING UNITS: METER
PREPARED BY: AMTEL RESOURCES SDN BHD	INITIAL & DATE: -
DESIGNED BY: JEMI	INITIAL & DATE: -
CHECKED BY: FAZWAN	INITIAL & DATE: -
APPROVED BY: -	INITIAL & DATE: -

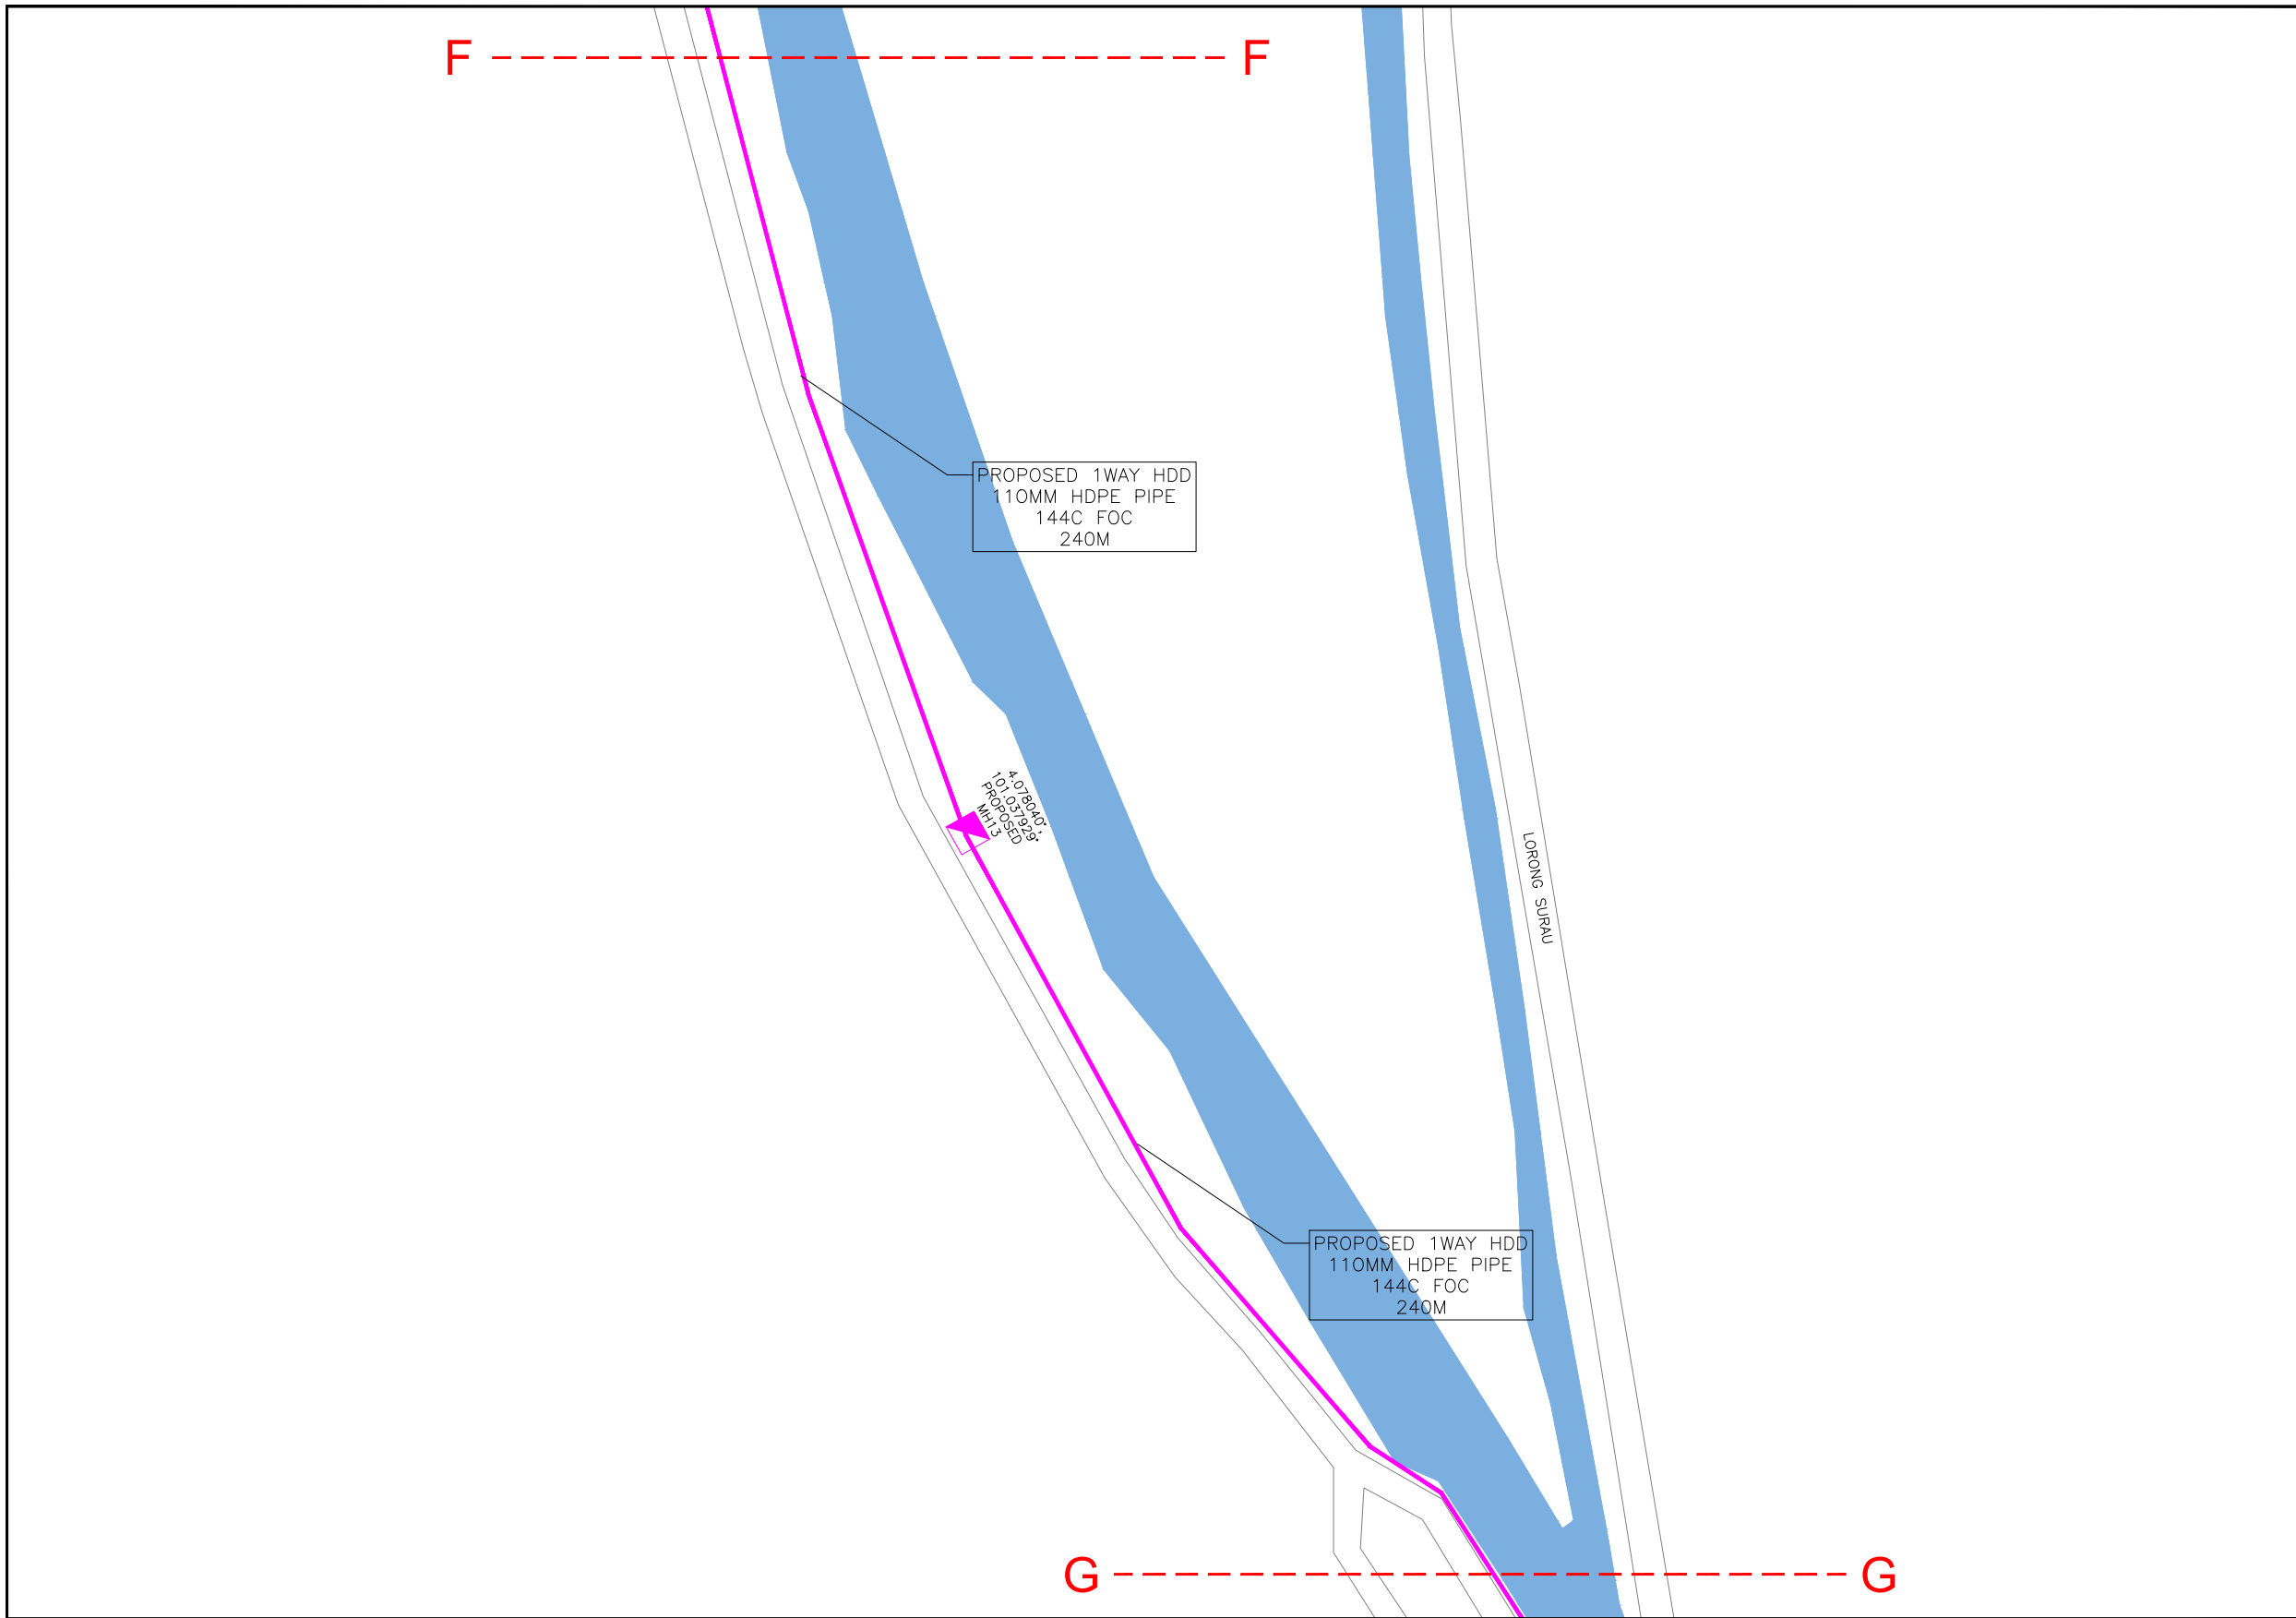

KELULUSAN PLAN

Local Authorities:-

CONFIDENTIALITY

These drawings and details are and shall remain the property of TT dotCom Sdn Bhd. Both are issued in strict confidence and shall not be reproduced, copied or used in any manner without specific written permission from the owner.

LEGEND :- OUTSIDE PLANT

- = BUILDING MANHOLE
- = BUILDING PIT
- = PROPOSED TIME MANHOLE
- = EXISTING TIME MANHOLE
- = PROPOSED TIME DUCT ROUTE
- = PROPOSED TIME DUCT TO BUILDING
- = EXISTING BUILDING DUCT ROUTE
- = EXISTING BUILDING CABLE TRAY
- = PROPOSED TRUNKING
- = PROPOSED CONDUIT
- = CLAIM AREA
- 1W / 2W = 1 WAY OR 2 WAY DUCT
- GI = GALVANISED IRON DUCT
- PVC = PVC DUCT
- = HIDDEN DRAIN
- = VISIBLE DRAIN
- = TREES AND PLANTS

REV. NO.	REV. DATE	REV. BY	DESCRIPTION:




TT dotCom Sdn Bhd (52371-A)  
 No 14, Jalan Majistret U1/26,  
 Hicom Glenmarie Industrial Park  
 40150 Shah Alam, Selangor Darul Ehsan, Malaysia.  
 Tel: +60 3 5032 6000  
 Website: www.time.com.my

PROJECT TITLE: FTK NEW 1W UNDERGROUND CIVIL & 1X144F CABLE PULLING INFRASTRUCTURE FROM BIDOR – H.MELINTANG (PACKAGE 4)	
DRAWING TITLE: PROPOSED DRAWING (PREVENTIVE MAINTENANCE WITH ANTI RODENT 144C FIBER)	
DRAWING NO: TTdC/0000/UMOB/LEML/0001	SHEET NO: 31 OF 7

DRAWING SCALE: N.T.S	DRAWING UNITS: METER
PREPARED BY: AMTEL RESOURCES SDN BHD	INITIAL & DATE: -
DESIGNED BY: JEMI	INITIAL & DATE: -
CHECKED BY: FAZWAN	INITIAL & DATE: -
APPROVED BY: -	INITIAL & DATE: -

G - - - - - G

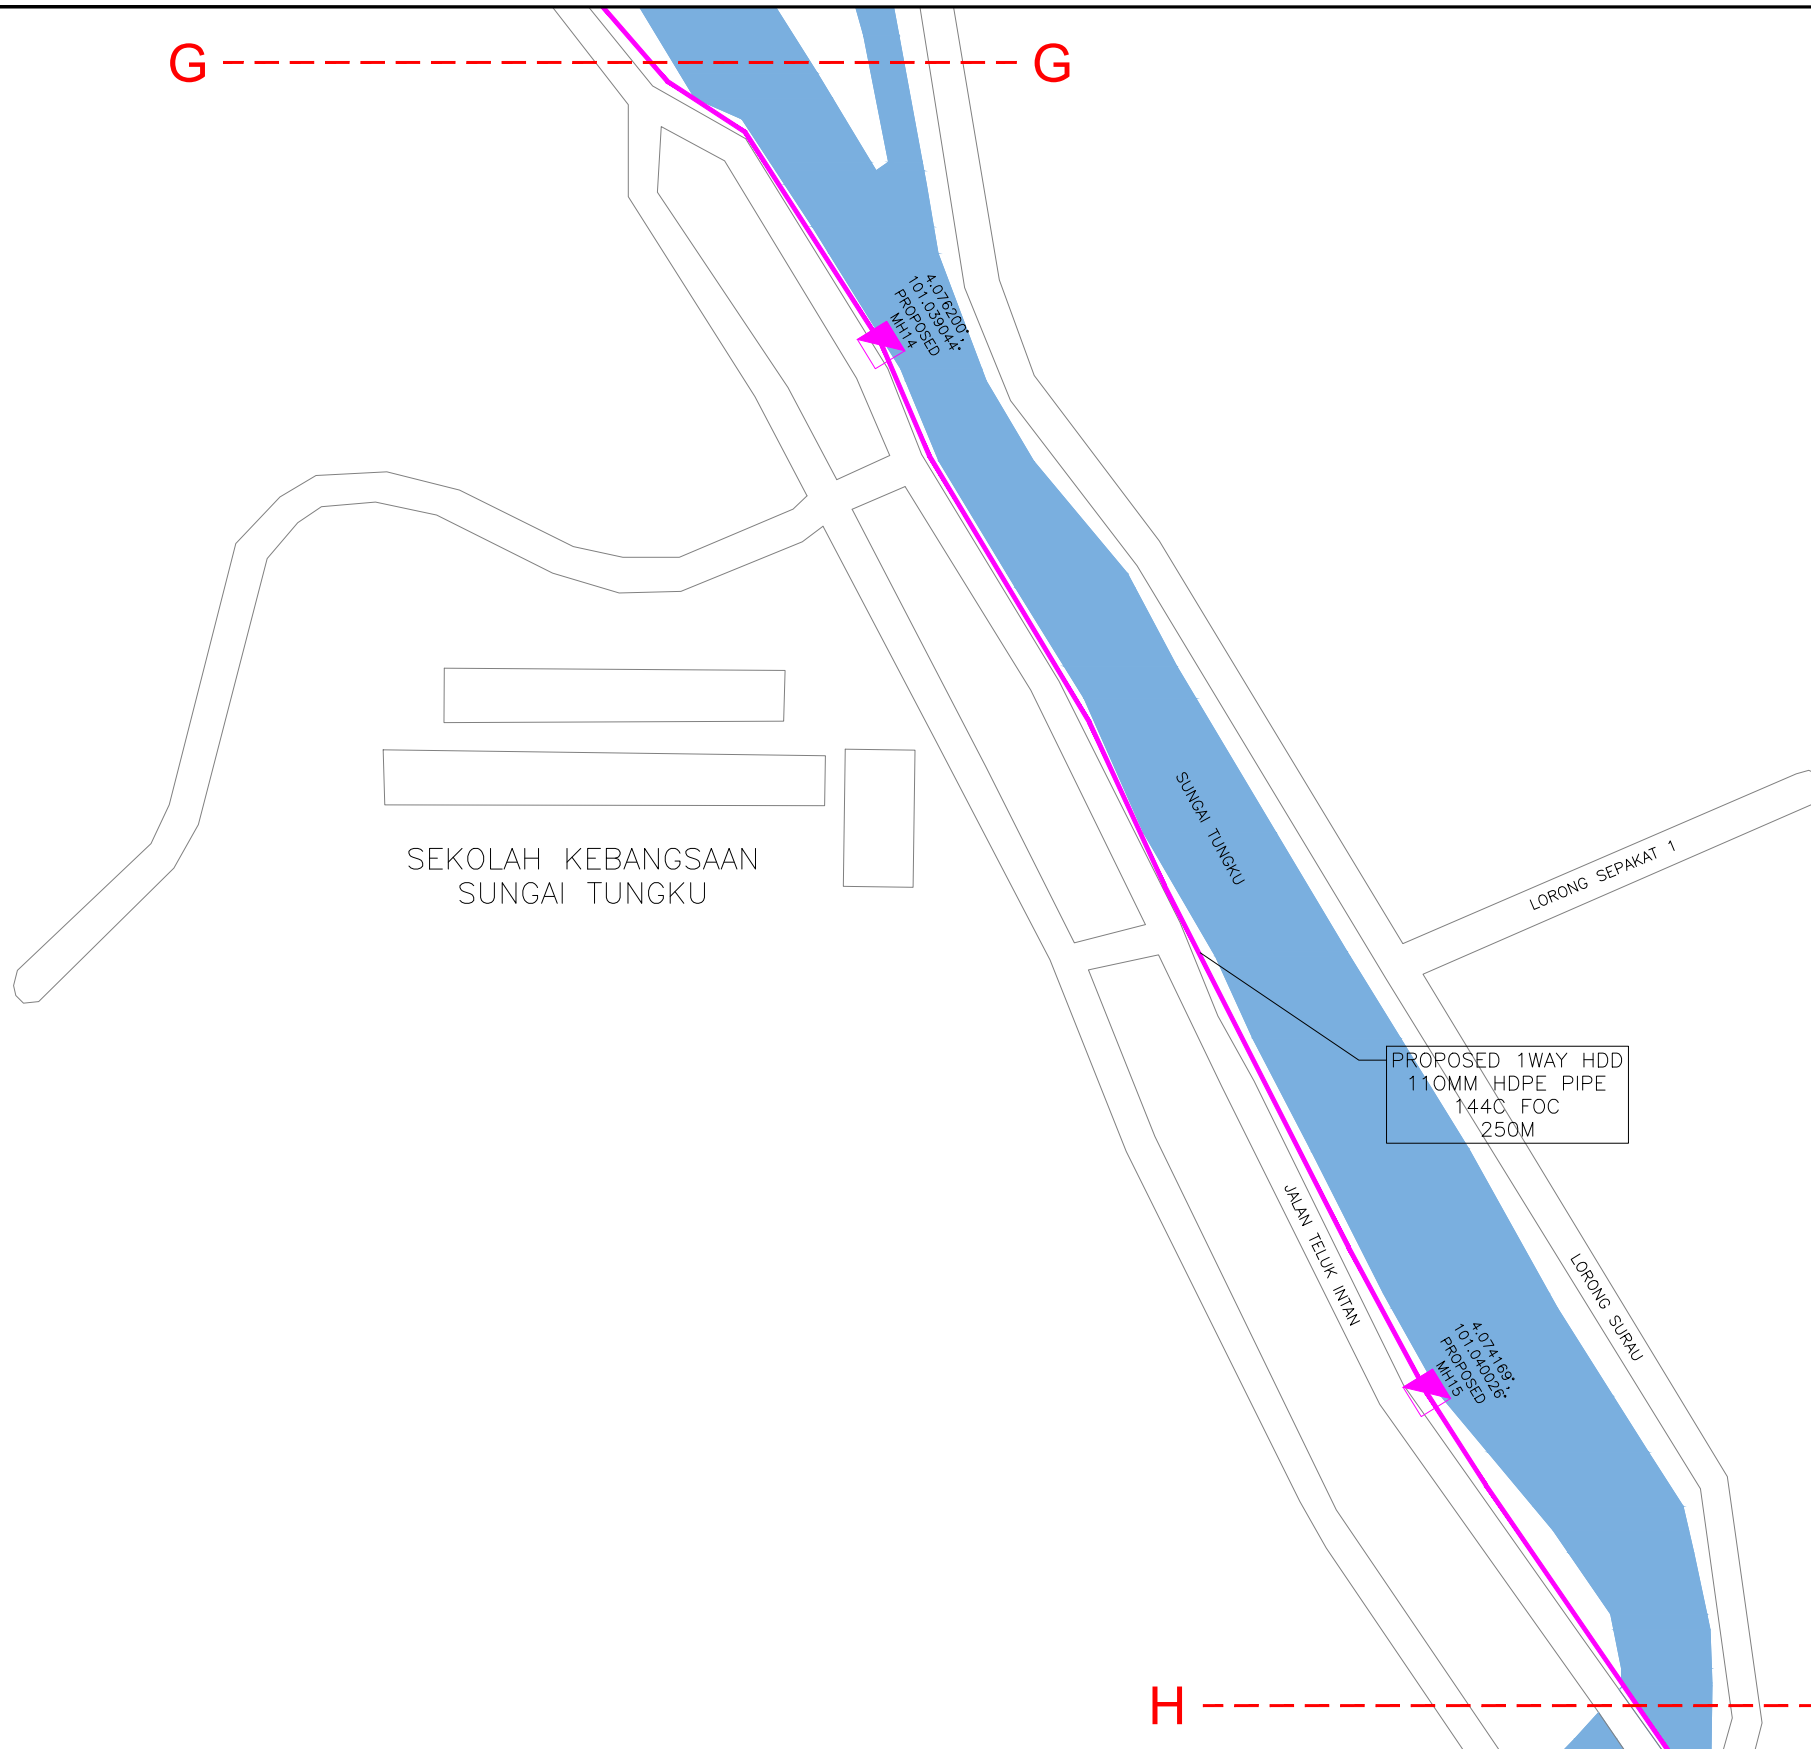

H - - - - - H

KELULUSAN PLAN

Local Authorities:-

CONFIDENTIALITY

These drawings and details are and shall remain the property of TT dotCom Sdn Bhd. Both are issued in strict confidence and shall not be reproduced, copied or used in any manner without specific written permission from the owner.

LEGEND :- OUTSIDE PLANT

- = BUILDING MANHOLE
- = BUILDING PIT
- = PROPOSED TIME MANHOLE
- = EXISTING TIME MANHOLE
- = PROPOSED TIME DUCT ROUTE
- = PROPOSED TIME DUCT TO BUILDING
- = EXISTING BUILDING DUCT ROUTE
- = EXISTING BUILDING CABLE TRAY
- = PROPOSED TRUNKING
- = PROPOSED CONDUIT
- = CLAIM AREA
- 1W / 2W = 1 WAY OR 2 WAY DUCT
- GI = GALVANISED IRON DUCT
- PVC = PVC DUCT
- = HIDDEN DRAIN
- = VISIBLE DRAIN
- = TREES AND PLANTS


REV. NO.	REV. DATE	REV. BY	DESCRIPTION:



TT dotCom Sdn Bhd (52371-A)  
 No 14, Jalan Majistret U1/26,  
 Hicom Glenmarie Industrial Park  
 40150 Shah Alam, Selangor Darul Ehsan, Malaysia.  
 Tel: +60 3 5032 6000  
 Website: www.time.com.my

PROJECT TITLE: FTK NEW 1W UNDERGROUND CIVIL & 1X144F CABLE PULLING INFRASTRUCTURE FROM BIDOR – H.MELINTANG (PACKAGE 4)	
DRAWING TITLE: PROPOSED DRAWING (PREVENTIVE MAINTENANCE WITH ANTI RODENT 144C FIBER)	
DRAWING NO: TTdC/0000/UMOB/LEML/0001	SHEET NO: 31 OF 8

DRAWING SCALE: N.T.S	DRAWING UNITS: METER
PREPARED BY: AMTEL RESOURCES SDN BHD	INITIAL & DATE: -
DESIGNED BY: JEMI	INITIAL & DATE: -
CHECKED BY: FAZWAN	INITIAL & DATE: -
APPROVED BY: -	INITIAL & DATE: -

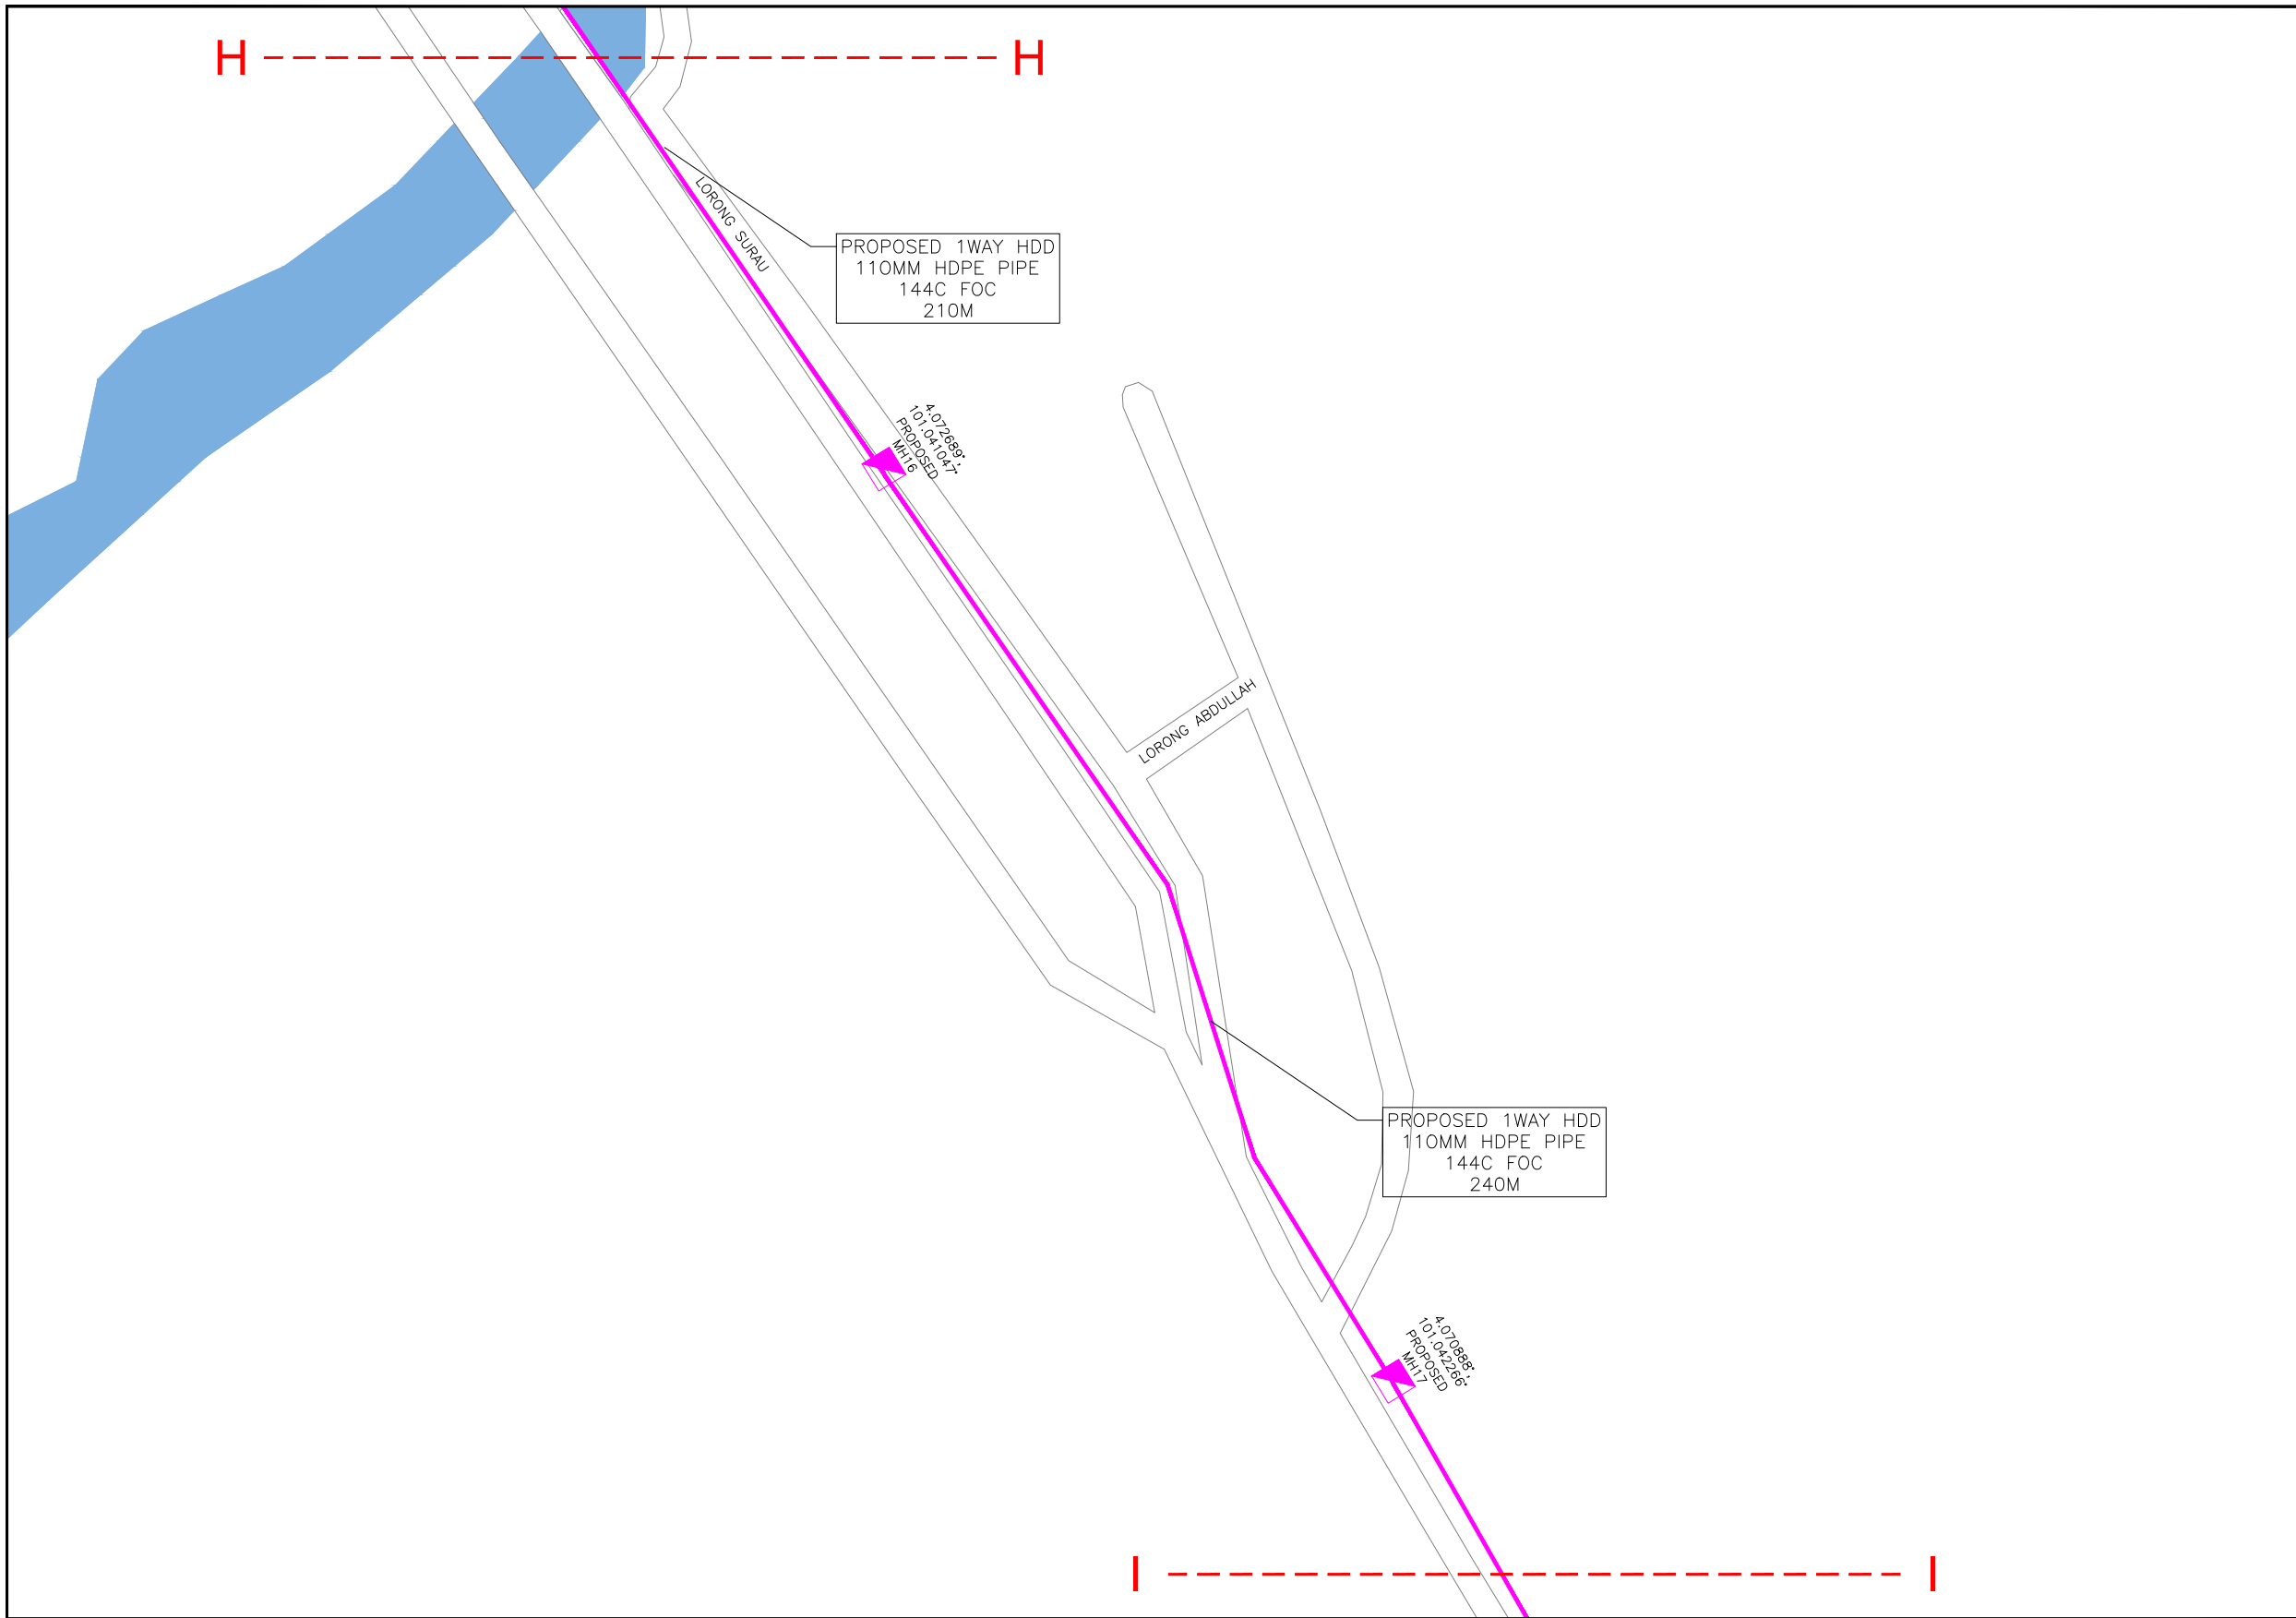











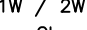



KELULUSAN PLAN

Local Authorities:-

CONFIDENTIALITY

These drawings and details are and shall remain the property of TT dotCom Sdn Bhd. Both are issued in strict confidence and shall not be reproduced, copied or used in any manner without specific written permission from the owner.

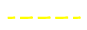LEGEND :- OUTSIDE PLANT

-  = BUILDING MANHOLE
-  = BUILDING PIT
-  = PROPOSED TIME MANHOLE
-  = EXISTING TIME MANHOLE
-  = PROPOSED TIME DUCT ROUTE
-  = PROPOSED TIME DUCT TO BUILDING
-  = EXISTING BUILDING DUCT ROUTE
-  = EXISTING BUILDING CABLE TRAY
-  = PROPOSED TRUNKING
-  = PROPOSED CONDUIT
-  = CLAIM AREA
- 1W / 2W = 1 WAY OR 2 WAY DUCT
- GI = GALVANISED IRON DUCT
- PVC = PVC DUCT
-  = HIDDEN DRAIN
-  = VISIBLE DRAIN
-  = TREES AND PLANTS

REV. NO.	REV. DATE	REV. BY	DESCRIPTION:



TT dotCom Sdn Bhd (52371-A)  
 No 14, Jalan Majistret U1/26,  
 Hicom Glenmarie Industrial Park  
 40150 Shah Alam, Selangor Darul Ehsan, Malaysia.  
 Tel: +60 3 5032 6000  
 Website: www.time.com.my

PROJECT TITLE: FTK NEW 1W UNDERGROUND CIVIL & 1X144F CABLE PULLING INFRASTRUCTURE FROM BIDOR – H.MELINTANG (PACKAGE 4)	
DRAWING TITLE: PROPOSED DRAWING (PREVENTIVE MAINTENANCE WITH ANTI RODENT 144C FIBER)	
DRAWING NO: TTdC/0000/UMOB/LEML/0001	SHEET NO: 31 OF 9

DRAWING SCALE: N.T.S	DRAWING UNITS: METER
PREPARED BY: AMTEL RESOURCES SDN BHD	INITIAL & DATE: -
DESIGNED BY: JEMI	INITIAL & DATE: -
CHECKED BY: FAZWAN	INITIAL & DATE: -
APPROVED BY: -	INITIAL & DATE: -















KELULUSAN PLAN


Local Authorities:-

CONFIDENTIALITY

These drawings and details are and shall remain the property of TT dotCom Sdn Bhd. Both are issued in strict confidence and shall not be reproduced, copied or used in any manner without specific written permission from the owner.

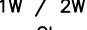LEGEND :- OUTSIDE PLANT

-  = BUILDING MANHOLE
-  = BUILDING PIT
-  = PROPOSED TIME MANHOLE
-  = EXISTING TIME MANHOLE
-  = PROPOSED TIME DUCT ROUTE
-  = PROPOSED TIME DUCT TO BUILDING
-  = EXISTING BUILDING DUCT ROUTE
-  = EXISTING BUILDING CABLE TRAY
-  = PROPOSED TRUNKING
-  = PROPOSED CONDUIT
-  = CLAIM AREA
- 1W / 2W = 1 WAY OR 2 WAY DUCT
- GI = GALVANISED IRON DUCT
- PVC = PVC DUCT
-  = HIDDEN DRAIN
-  = VISIBLE DRAIN
-  = TREES AND PLANTS

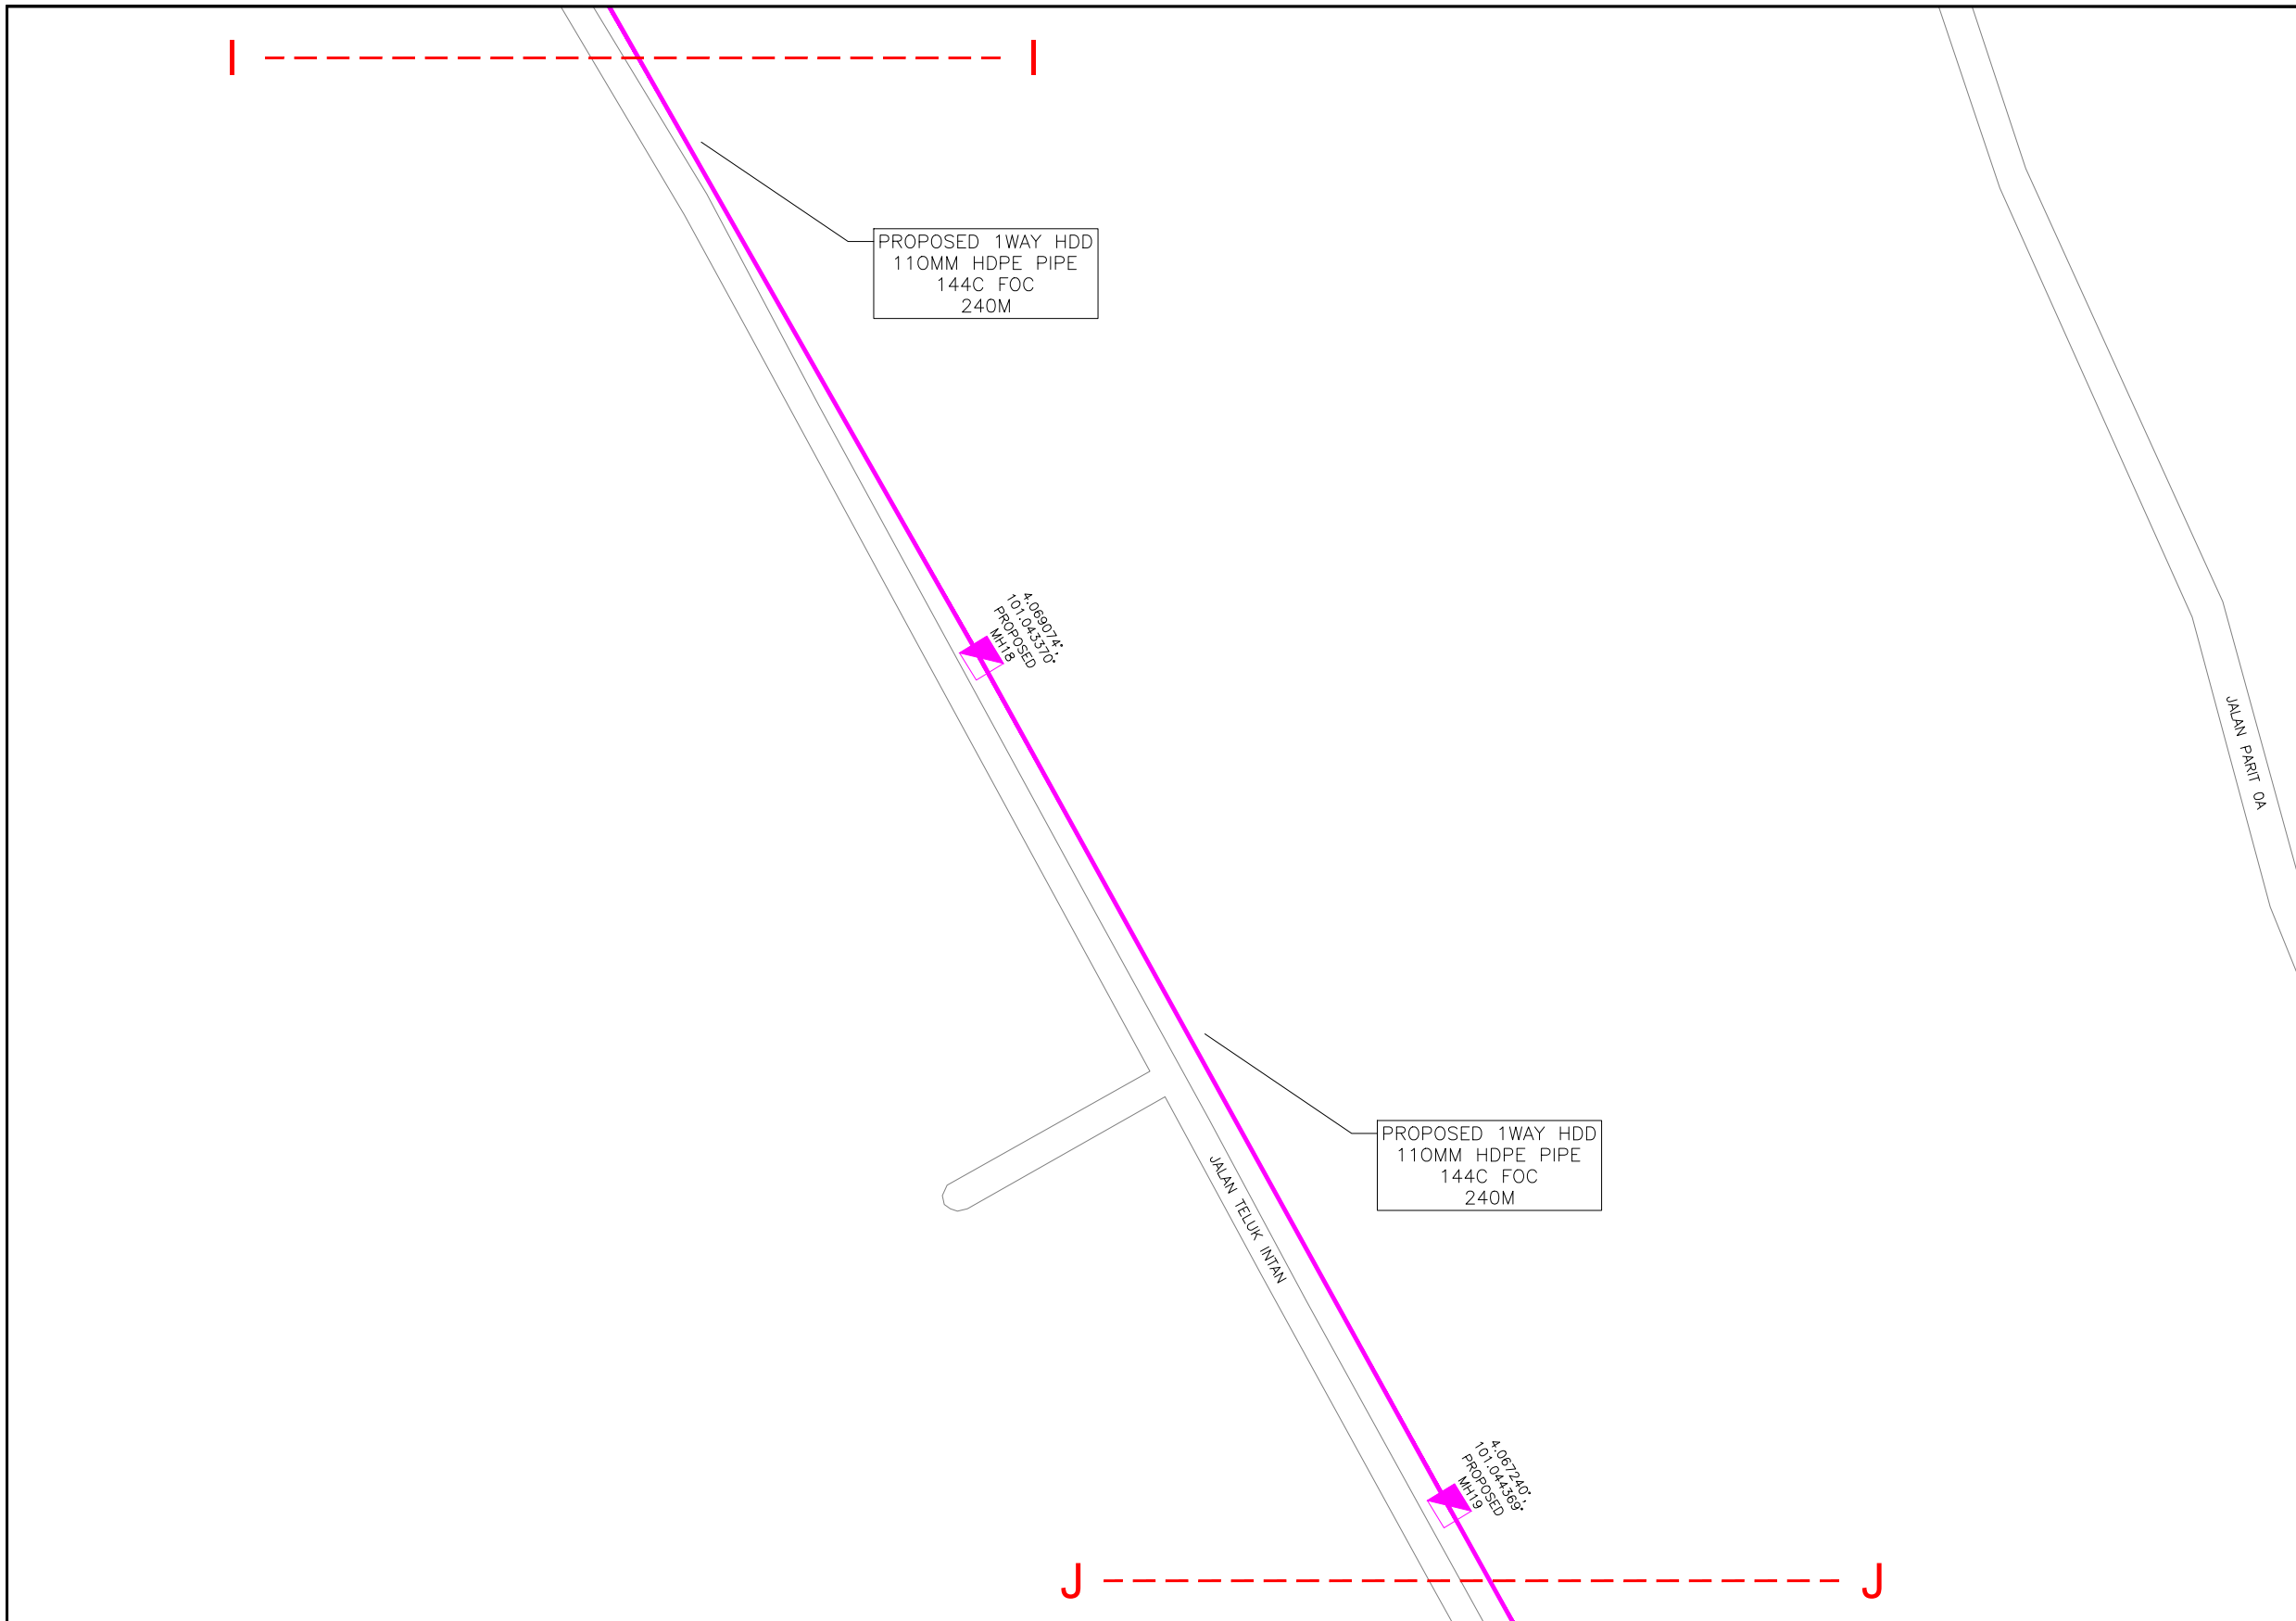

REV. NO.	REV. DATE	REV. BY	DESCRIPTION:




TT dotCom Sdn Bhd (52371-A)  
 No 14, Jalan Majistret U1/26,  
 Hicom Glenmarie Industrial Park  
 40150 Shah Alam, Selangor Darul Ehsan, Malaysia.  
 Tel: +60 3 5032 6000  
 Website: www.time.com.my

PROJECT TITLE:  
 FTK NEW 1W UNDERGROUND CIVIL & 1X144F CABLE PULLING INFRASTRUCTURE FROM BIDOR – H.MELINTANG (PACKAGE 4)

DRAWING TITLE:  
 PROPOSED DRAWING (PREVENTIVE MAINTENANCE WITH ANTI RODENT 144C FIBER)

DRAWING NO: TTdC/0000/UMOB/LEML/0001      SHEET NO: 31 OF 10

DRAWING SCALE: N.T.S	DRAWING UNITS: METER
PREPARED BY: AMTEL RESOURCES SDN BHD	INITIAL & DATE: -
DESIGNED BY: JEMI	INITIAL & DATE: -
CHECKED BY: FAZWAN	INITIAL & DATE: -
APPROVED BY: -	INITIAL & DATE: -

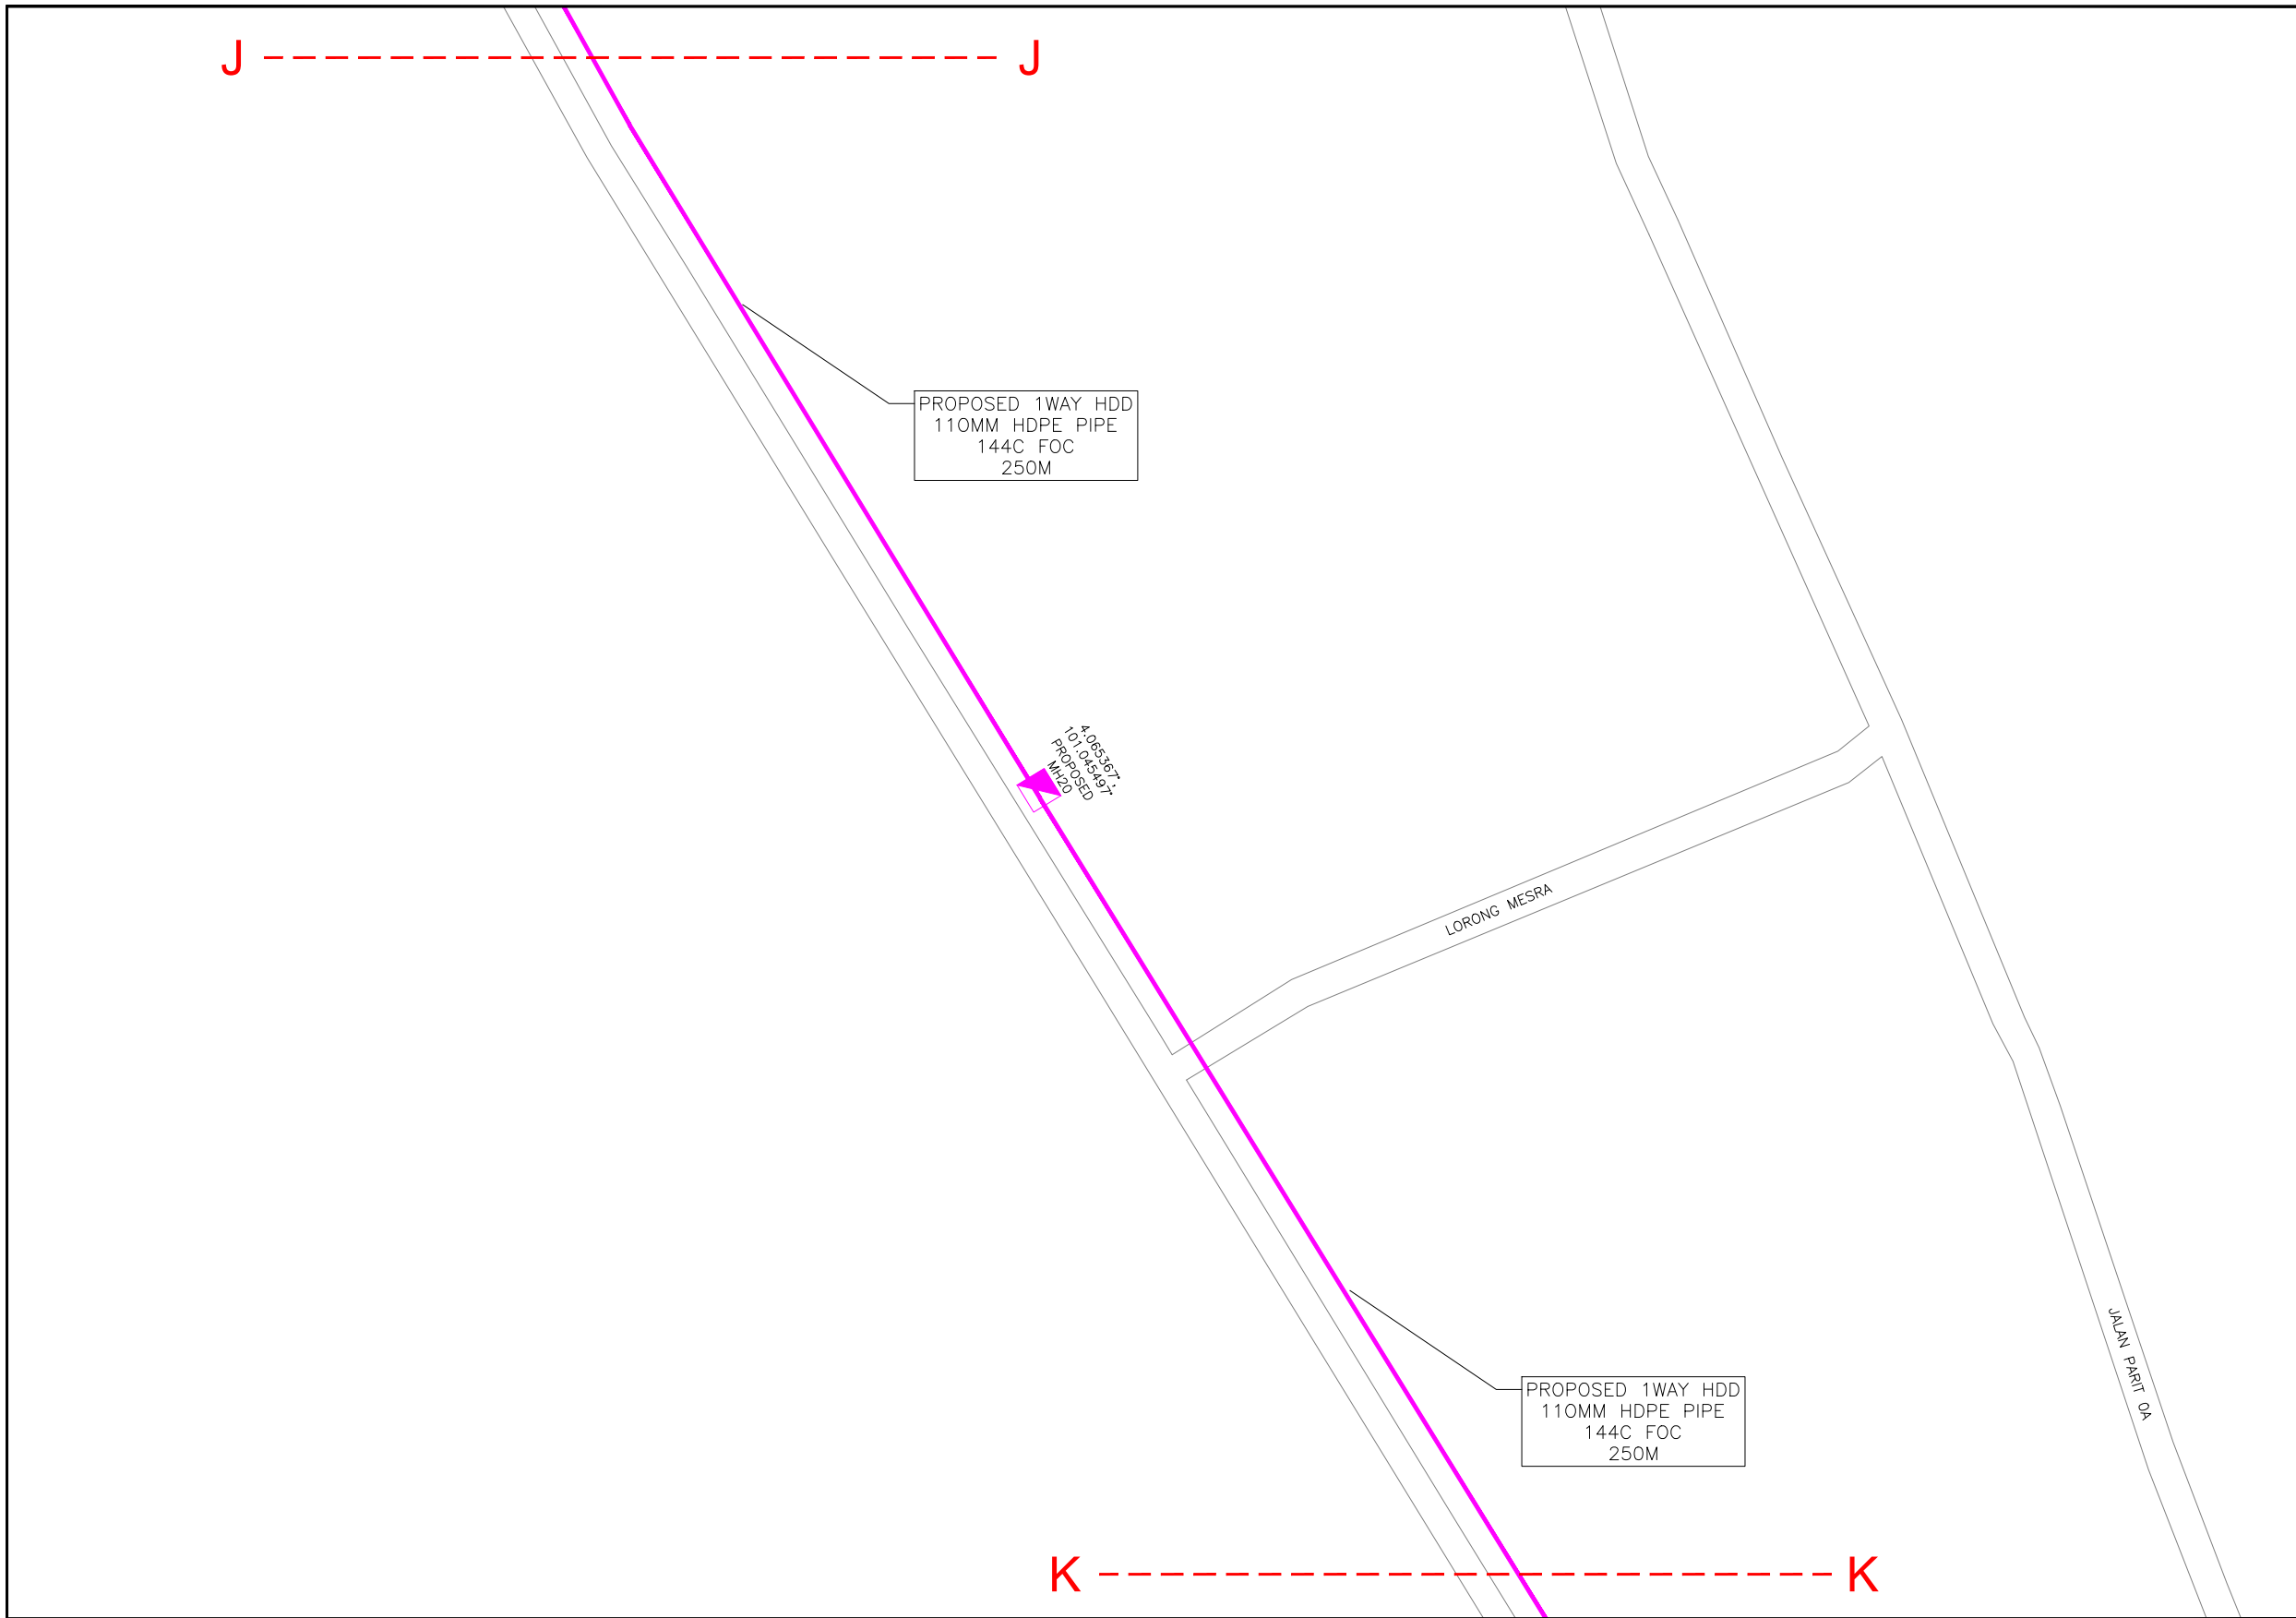

KELULUSAN PLAN

Local Authorities:--

CONFIDENTIALITY

These drawings and details are and shall remain the property of TT dotCom Sdn Bhd. Both are issued in strict confidence and shall not be reproduced, copied or used in any manner without specific written permission from the owner.

LEGEND :- OUTSIDE PLANT

- = BUILDING MANHOLE
- = BUILDING PIT
- = PROPOSED TIME MANHOLE
- = EXISTING TIME MANHOLE
- = PROPOSED TIME DUCT ROUTE
- = PROPOSED TIME DUCT TO BUILDING
- = EXISTING BUILDING DUCT ROUTE
- = EXISTING BUILDING CABLE TRAY
- = PROPOSED TRUNKING
- = PROPOSED CONDUIT
- = CLAIM AREA
- 1W / 2W = 1 WAY OR 2 WAY DUCT
- GI = GALVANISED IRON DUCT
- PVC = PVC DUCT
- = HIDDEN DRAIN
- = VISIBLE DRAIN
- = TREES AND PLANTS


REV. NO.	REV. DATE	REV. BY	DESCRIPTION:



TT dotCom Sdn Bhd (52371-A)  
 No 14, Jalan Majistret U1/26,  
 Hicom Glenmarie Industrial Park  
 40150 Shah Alam, Selangor Darul Ehsan, Malaysia.  
 Tel: +60 3 5032 6000  
 Website: www.time.com.my

PROJECT TITLE: FTK NEW 1W UNDERGROUND CIVIL & 1X144F CABLE PULLING INFRASTRUCTURE FROM BIDOR – H.MELINTANG (PACKAGE 4)	
DRAWING TITLE: PROPOSED DRAWING (PREVENTIVE MAINTENANCE WITH ANTI RODENT 144C FIBER)	
DRAWING NO: TTdC/0000/UMOB/LEML/0001	SHEET NO: 31 OF 11

DRAWING SCALE: N.T.S	DRAWING UNITS: METER
PREPARED BY: AMTEL RESOURCES SDN BHD	INITIAL & DATE: -
DESIGNED BY: JEMI	INITIAL & DATE: -
CHECKED BY: FAZWAN	INITIAL & DATE: -
APPROVED BY: -	INITIAL & DATE: -

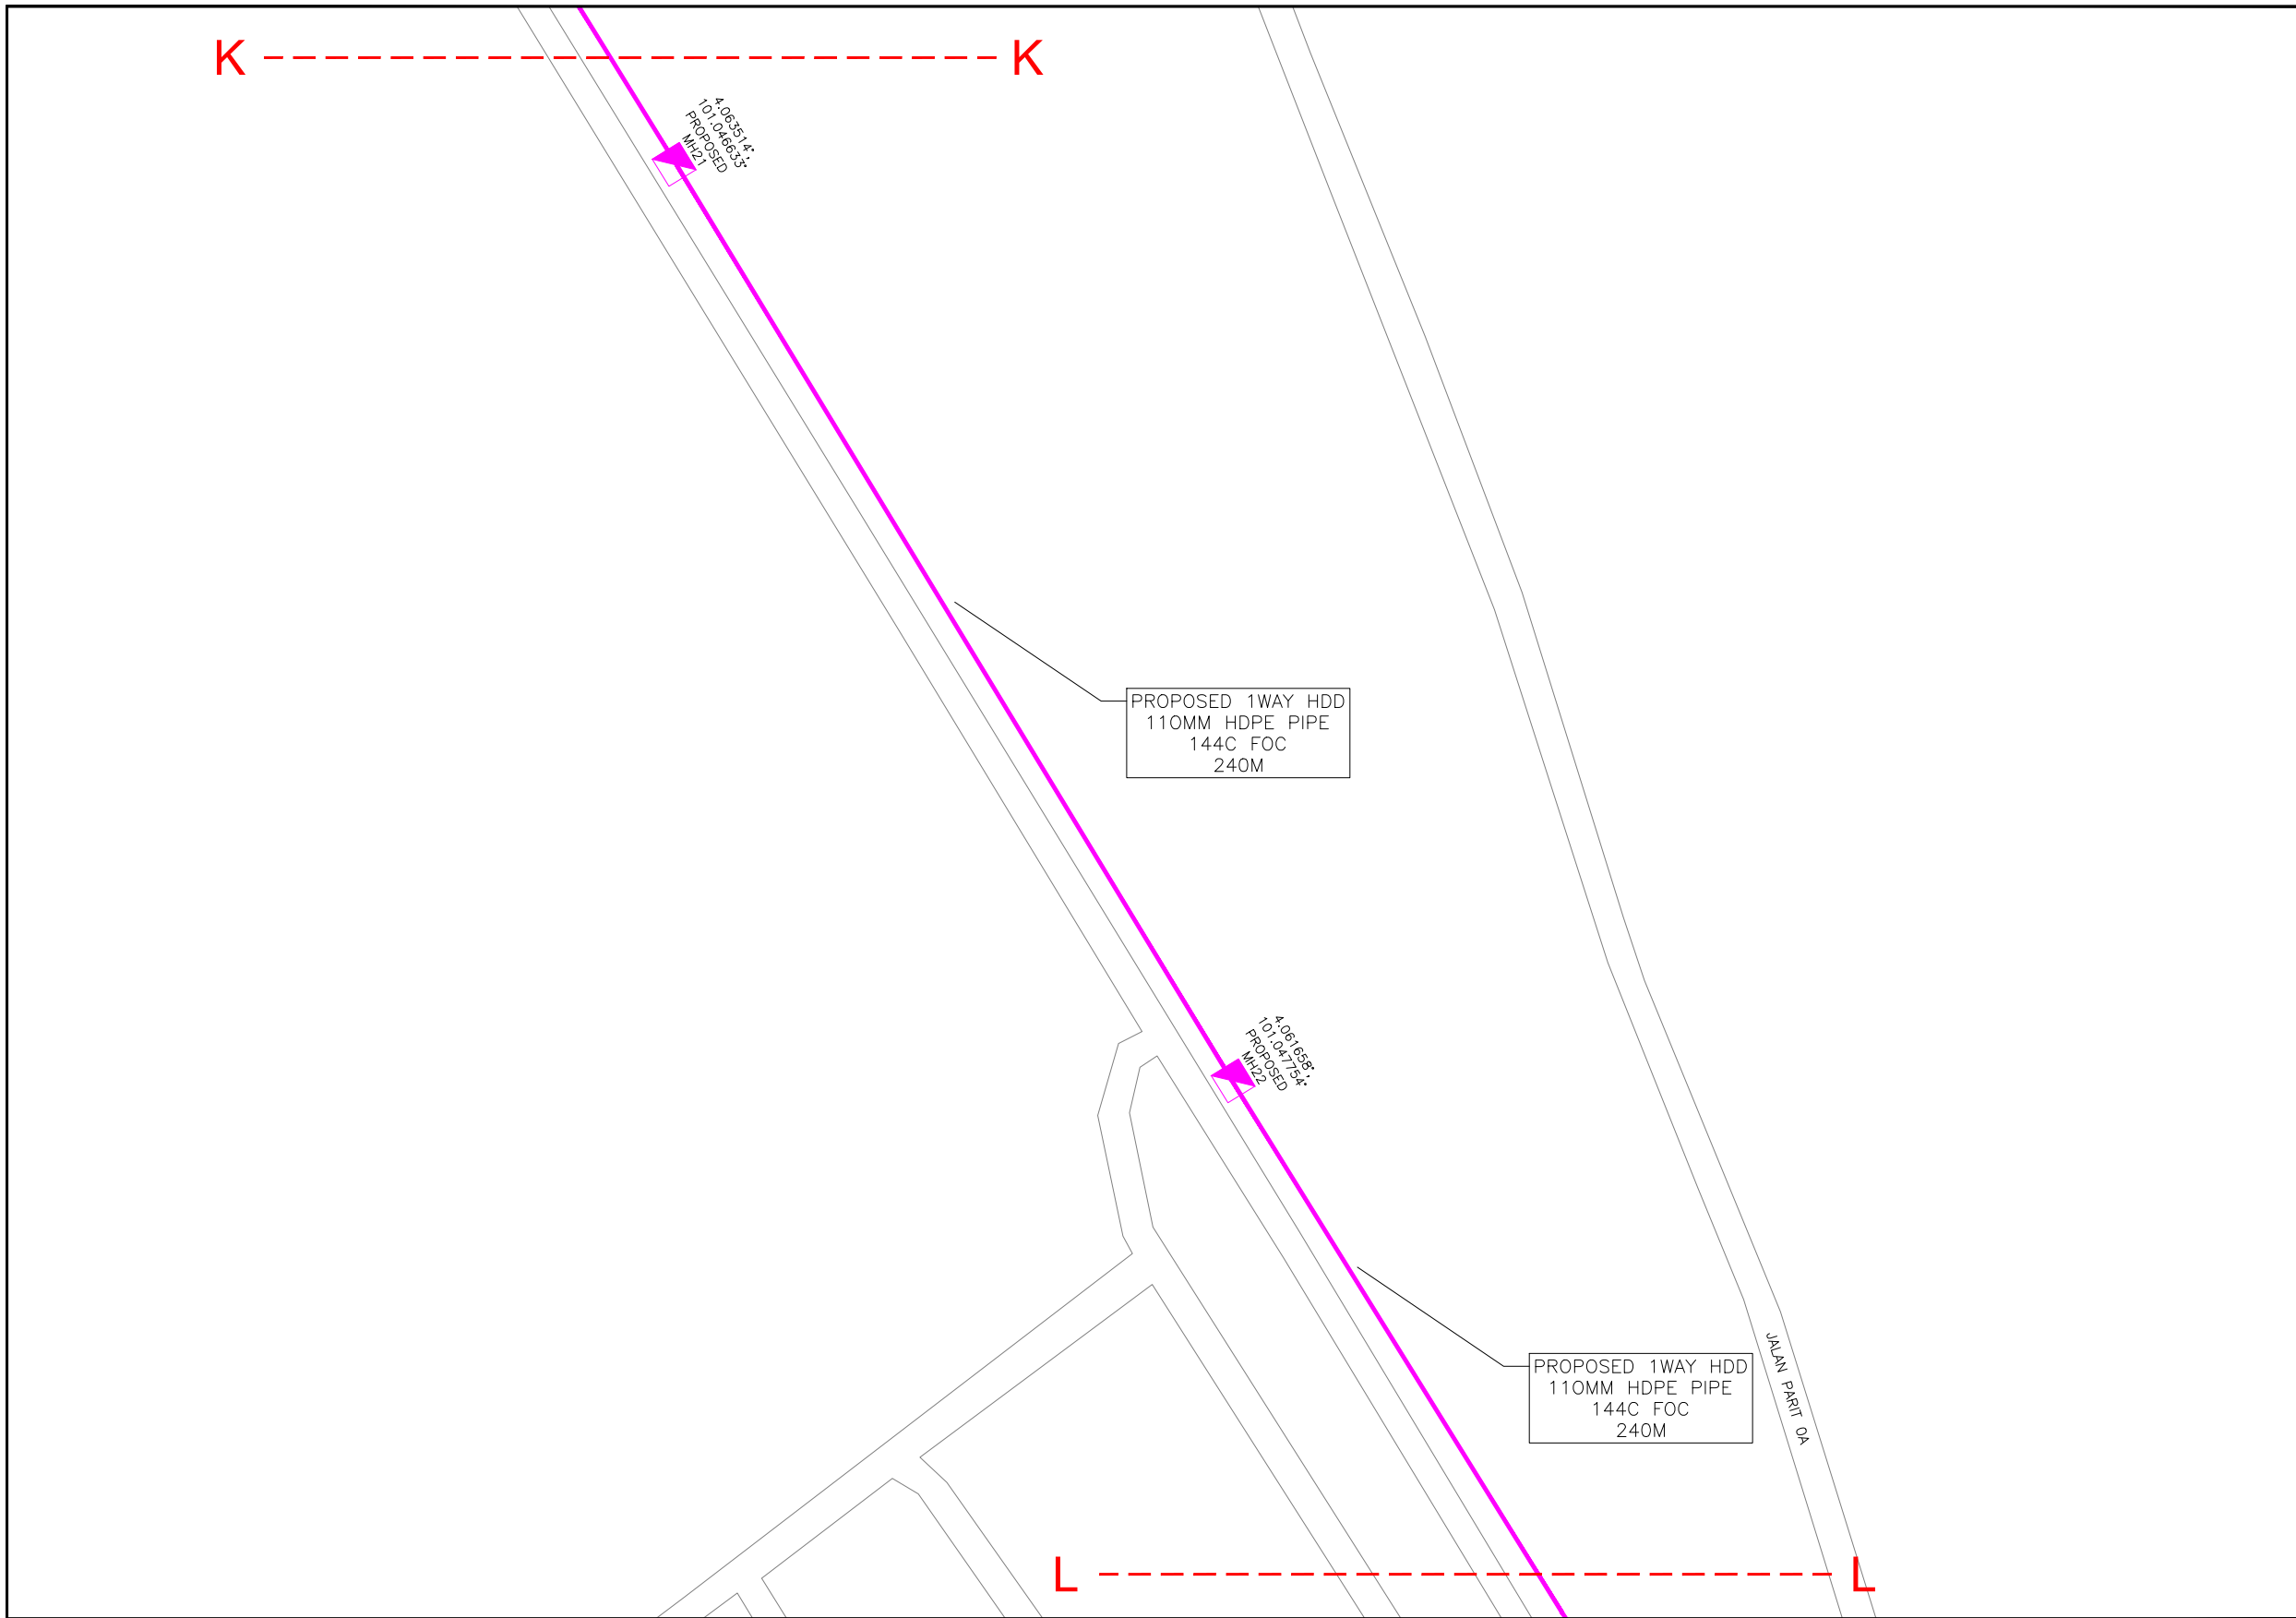

KELULUSAN PLAN

Local Authorities:-

CONFIDENTIALITY

These drawings and details are and shall remain the property of TT dotCom Sdn Bhd. Both are issued in strict confidence and shall not be reproduced, copied or used in any manner without specific written permission from the owner.

LEGEND :- OUTSIDE PLANT

- = BUILDING MANHOLE
- = BUILDING PIT
- = PROPOSED TIME MANHOLE
- = EXISTING TIME MANHOLE
- = PROPOSED TIME DUCT ROUTE
- = PROPOSED TIME DUCT TO BUILDING
- = EXISTING BUILDING DUCT ROUTE
- = EXISTING BUILDING CABLE TRAY
- = PROPOSED TRUNKING
- = PROPOSED CONDUIT
- = CLAIM AREA
- 1W / 2W = 1 WAY OR 2 WAY DUCT
- GI = GALVANISED IRON DUCT
- PVC = PVC DUCT
- = HIDDEN DRAIN
- = VISIBLE DRAIN
- = TREES AND PLANTS

REV. NO.	REV. DATE	REV. BY	DESCRIPTION:




TT dotCom Sdn Bhd (52371-A)  
 No 14, Jalan Majistret U1/26,  
 Hicom Glenmarie Industrial Park  
 40150 Shah Alam, Selangor Darul Ehsan, Malaysia.  
 Tel: +60 3 5032 6000  
 Website: www.time.com.my

PROJECT TITLE:  
 FTK NEW 1W UNDERGROUND CIVIL & 1X144F CABLE  
 PULLING INFRASTRUCTURE FROM  
 BIDOR – H.MELINTANG (PACKAGE 4)

DRAWING TITLE:  
 PROPOSED DRAWING  
 (PREVENTIVE MAINTENANCE WITH ANTI RODENT  
 144C FIBER)

DRAWING NO: TTdC/0000/UMOB/LEML/0001      SHEET NO: 31 OF 12

DRAWING SCALE: N.T.S	DRAWING UNITS: METER
PREPARED BY: AMTEL RESOURCES SDN BHD	INITIAL & DATE: -
DESIGNED BY: JEMI	INITIAL & DATE: -
CHECKED BY: FAZWAN	INITIAL & DATE: -
APPROVED BY: -	INITIAL & DATE: -

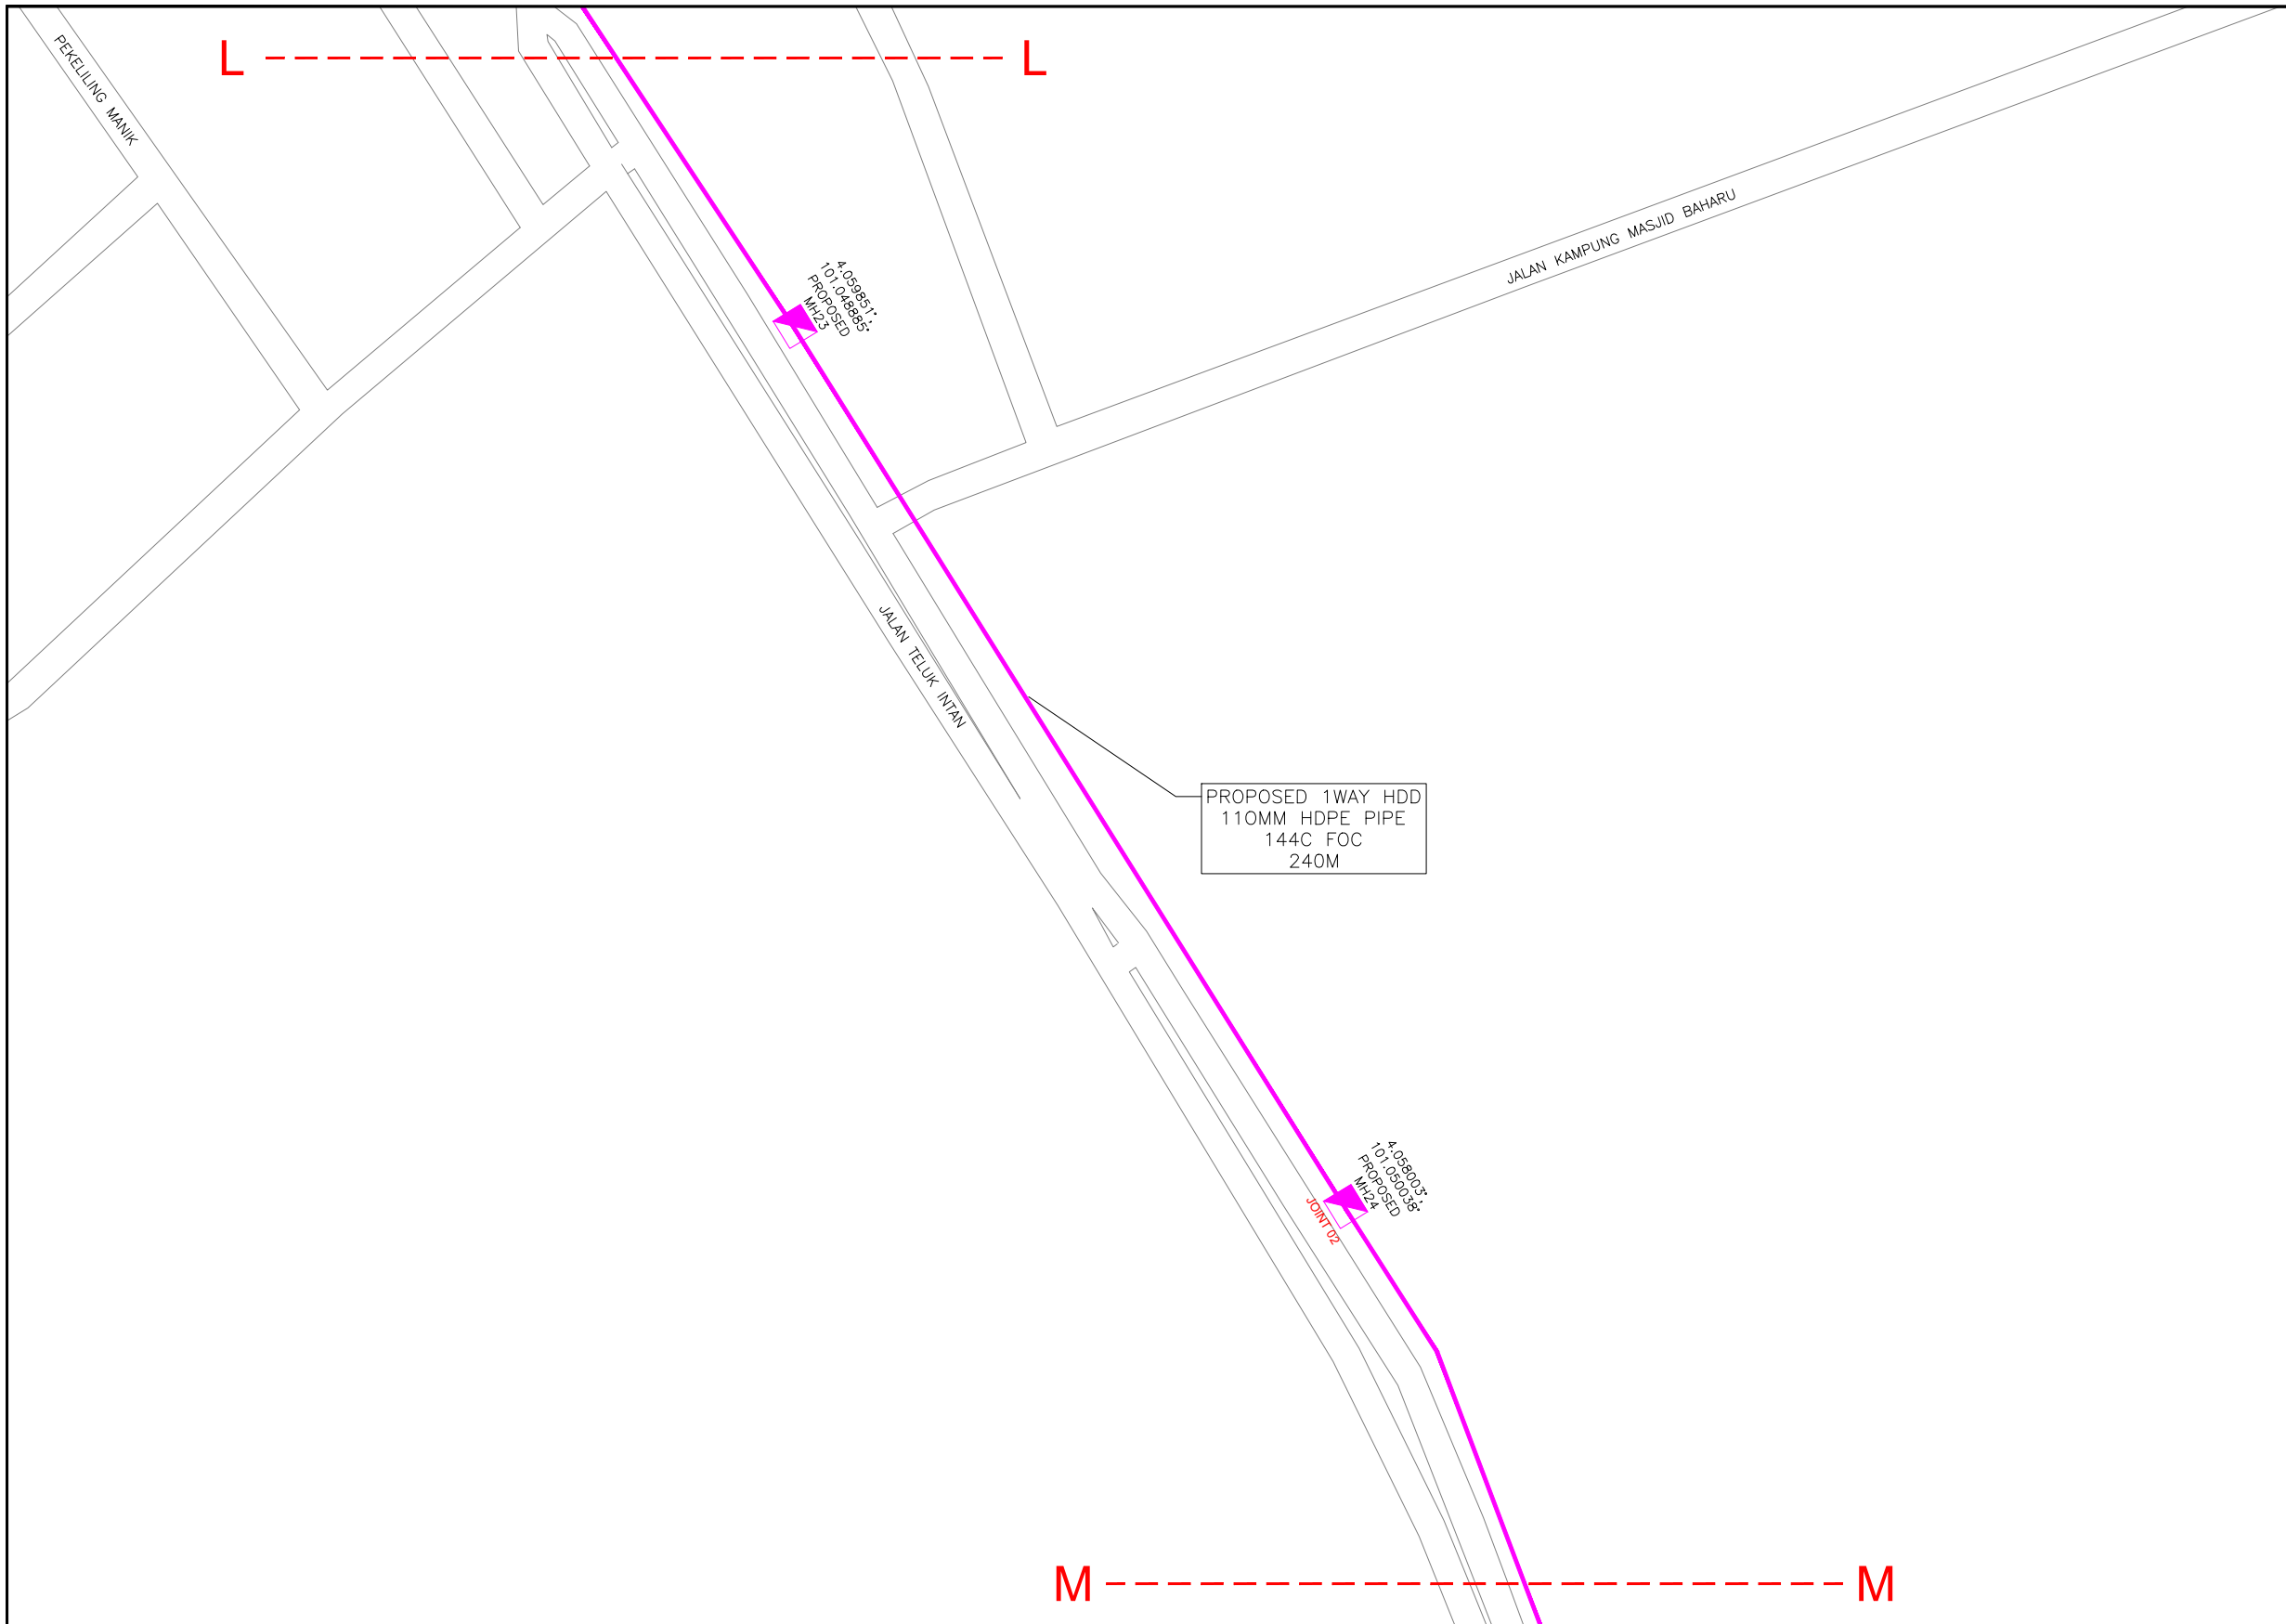

KELULUSAN PLAN

Local Authorities:--

CONFIDENTIALITY

These drawings and details are and shall remain the property of TT dotCom Sdn Bhd. Both are issued in strict confidence and shall not be reproduced, copied or used in any manner without specific written permission from the owner.

LEGEND :- OUTSIDE PLANT

- = BUILDING MANHOLE
- = BUILDING PIT
- = PROPOSED TIME MANHOLE
- = EXISTING TIME MANHOLE
- = PROPOSED TIME DUCT ROUTE
- = PROPOSED TIME DUCT TO BUILDING
- = EXISTING BUILDING DUCT ROUTE
- = EXISTING BUILDING CABLE TRAY
- = PROPOSED TRUNKING
- = PROPOSED CONDUIT
- = CLAIM AREA
- 1W / 2W = 1 WAY OR 2 WAY DUCT
- GI = GALVANISED IRON DUCT
- PVC = PVC DUCT
- = HIDDEN DRAIN
- = VISIBLE DRAIN
- = TREES AND PLANTS

REV. NO.	REV. DATE	REV. BY	DESCRIPTION:




TT dotCom Sdn Bhd (52371-A)  
 No 14, Jalan Majistret U1/26,  
 Hicom Glenmarie Industrial Park  
 40150 Shah Alam, Selangor Darul Ehsan, Malaysia.  
 Tel: +60 3 5032 6000  
 Website: www.time.com.my

PROJECT TITLE:  
 FTK NEW 1W UNDERGROUND CIVIL & 1X144F CABLE  
 PULLING INFRASTRUCTURE FROM  
 BIDOR – H.MELINTANG (PACKAGE 4)

DRAWING TITLE:  
 PROPOSED DRAWING  
 (PREVENTIVE MAINTENANCE WITH ANTI RODENT  
 144C FIBER)

DRAWING NO: TTdC/0000/UMOB/LEML/0001      SHEET NO: 31 OF 13

DRAWING SCALE: N.T.S	DRAWING UNITS: METER
PREPARED BY: AMTEL RESOURCES SDN BHD	INITIAL & DATE: -
DESIGNED BY: JEMI	INITIAL & DATE: -
CHECKED BY: FAZWAN	INITIAL & DATE: -
APPROVED BY: -	INITIAL & DATE: -

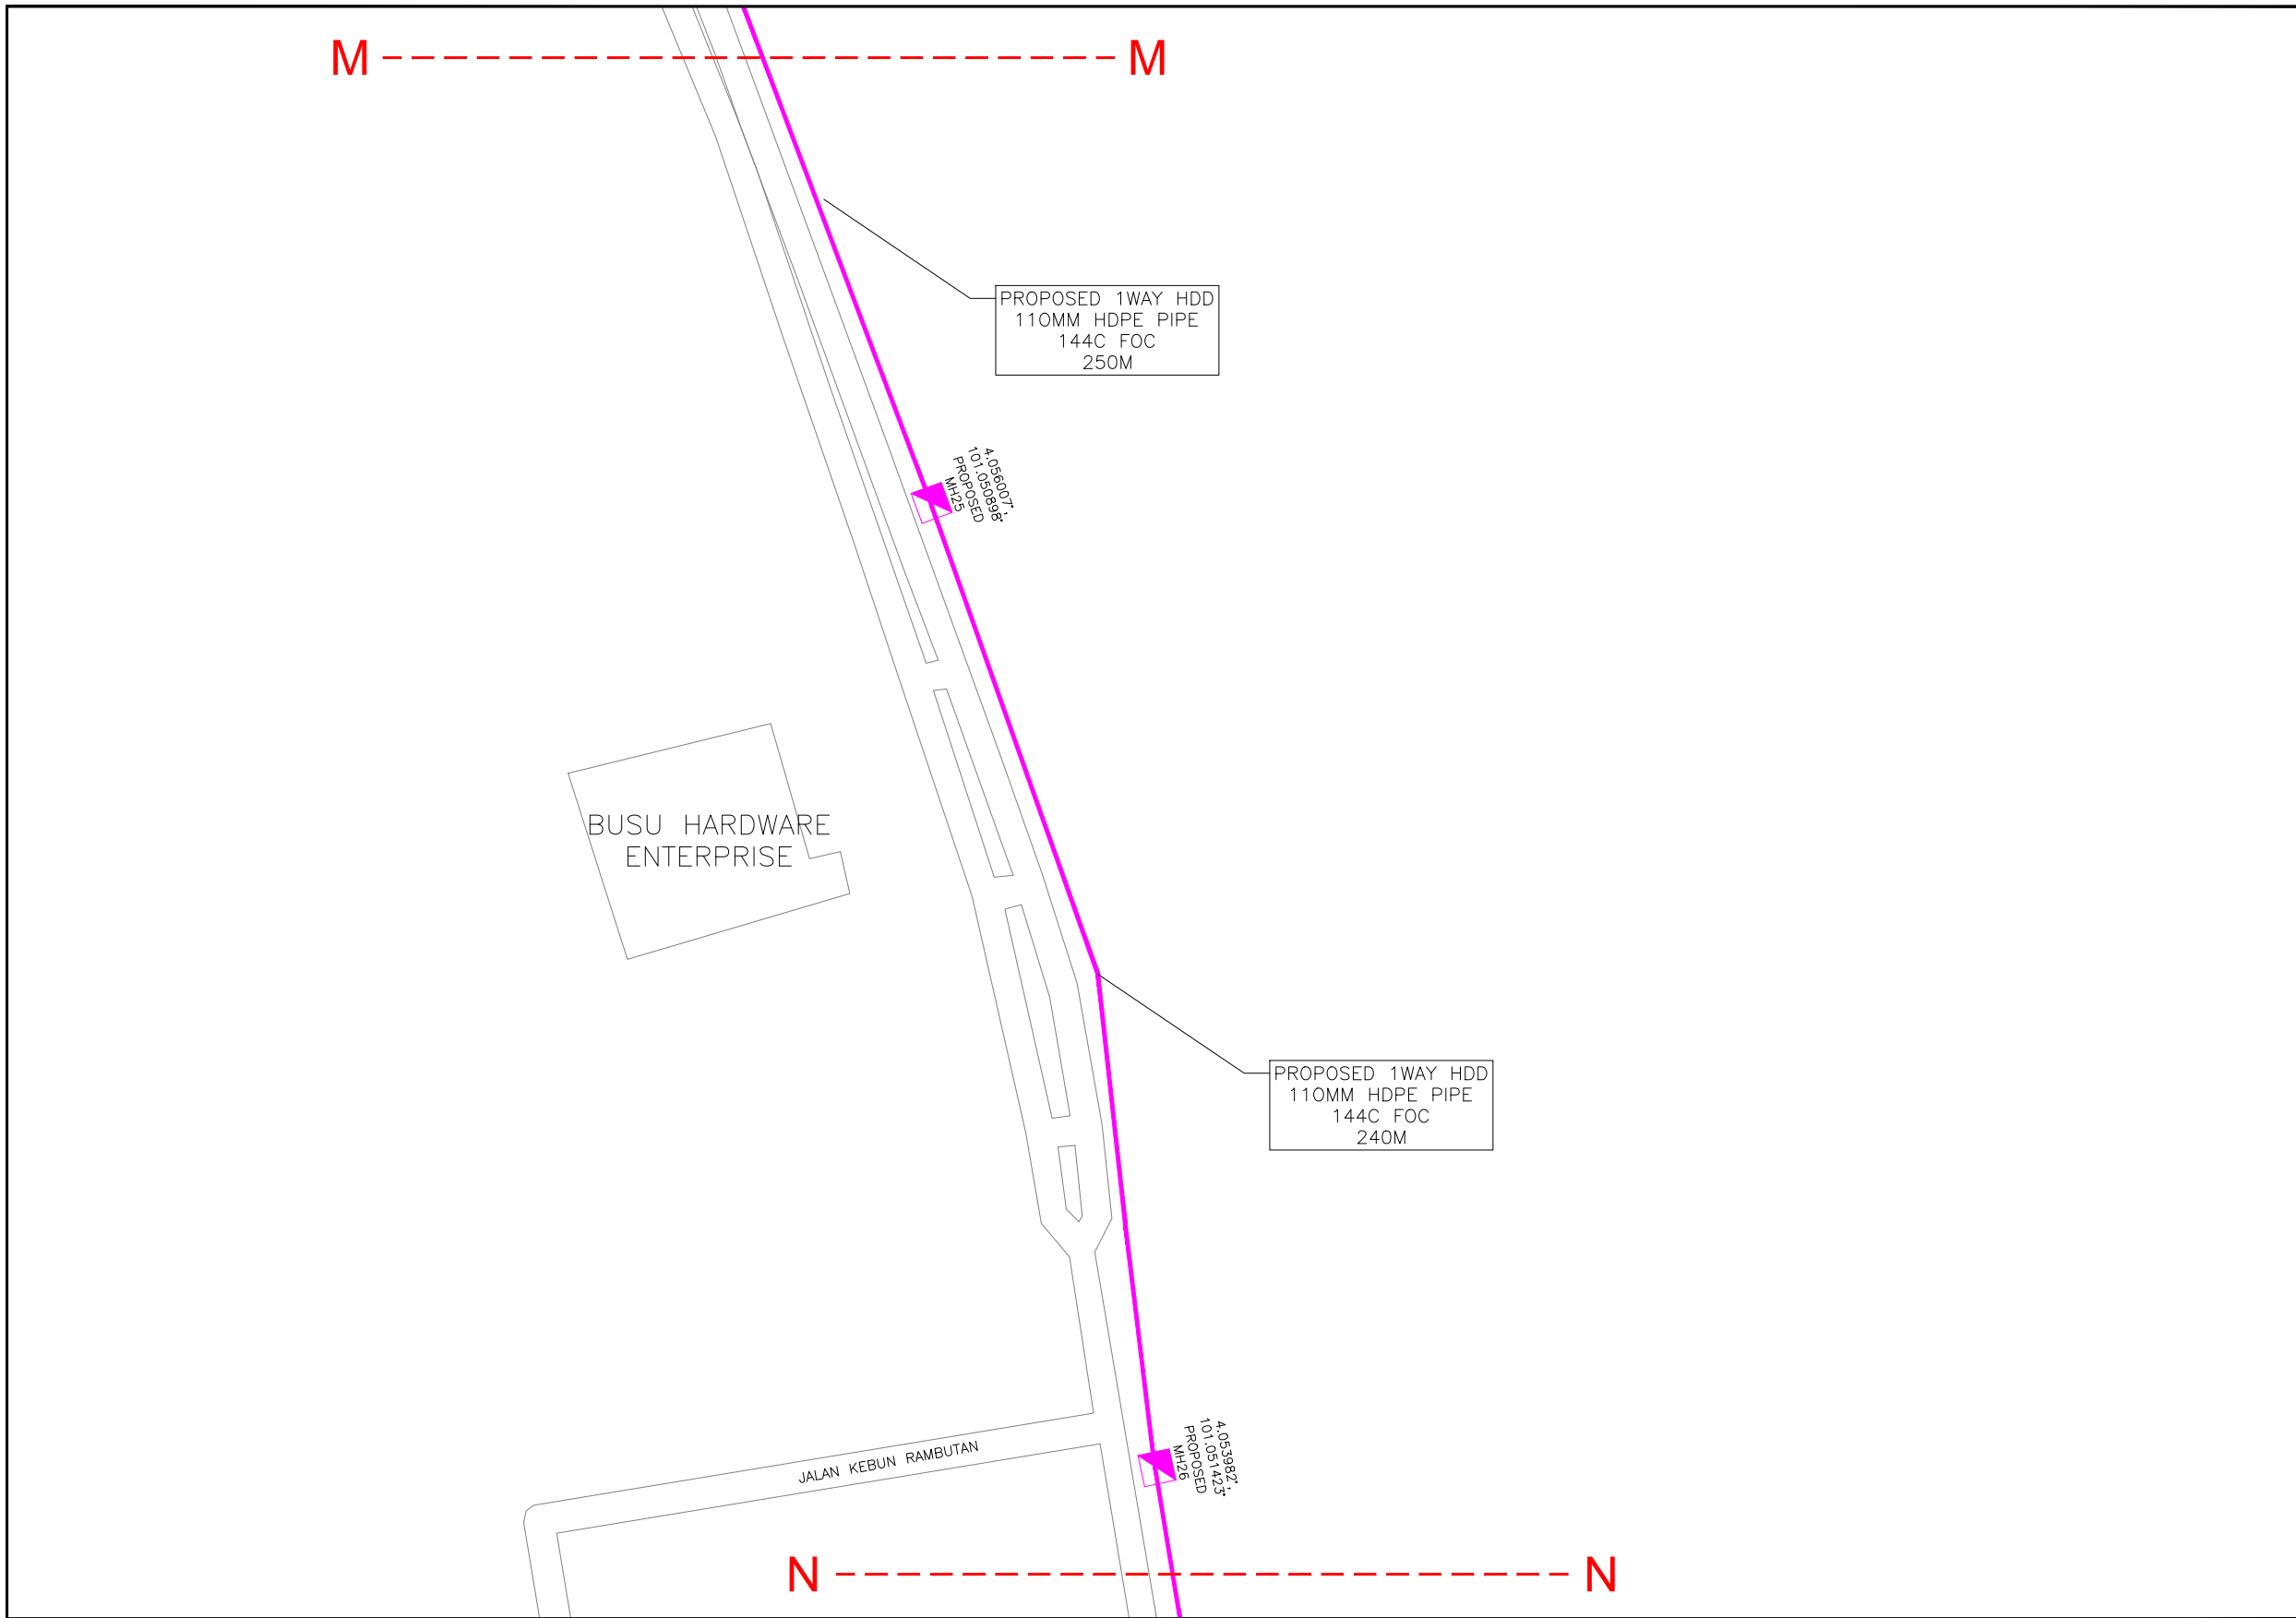

KELULUSAN PLAN

Local Authorities:-

CONFIDENTIALITY

These drawings and details are and shall remain the property of TT dotCom Sdn Bhd. Both are issued in strict confidence and shall not be reproduced, copied or used in any manner without specific written permission from the owner.

LEGEND :- OUTSIDE PLANT

- = BUILDING MANHOLE
- = BUILDING PIT
- = PROPOSED TIME MANHOLE
- = EXISTING TIME MANHOLE
- = PROPOSED TIME DUCT ROUTE
- = PROPOSED TIME DUCT TO BUILDING
- = EXISTING BUILDING DUCT ROUTE
- = EXISTING BUILDING CABLE TRAY
- = PROPOSED TRUNKING
- = PROPOSED CONDUIT
- = CLAIM AREA
- 1W / 2W = 1 WAY OR 2 WAY DUCT
- GI = GALVANISED IRON DUCT
- PVC = PVC DUCT
- = HIDDEN DRAIN
- = VISIBLE DRAIN
- = TREES AND PLANTS


REV. NO.	REV. DATE	REV. BY	DESCRIPTION:



TT dotCom Sdn Bhd (52371-A)  
 No 14, Jalan Majistret U1/26,  
 Hicom Glenmarie Industrial Park  
 40150 Shah Alam, Selangor Darul Ehsan, Malaysia.  
 Tel: +60 3 5032 6000  
 Website: www.time.com.my

PROJECT TITLE: FTK NEW 1W UNDERGROUND CIVIL & 1X144F CABLE PULLING INFRASTRUCTURE FROM BIDOR – H.MELINTANG (PACKAGE 4)	
DRAWING TITLE: PROPOSED DRAWING (PREVENTIVE MAINTENANCE WITH ANTI RODENT 144C FIBER)	
DRAWING NO: TTdC/0000/UMOB/LEML/0001	SHEET NO: 31 OF 14

DRAWING SCALE: N.T.S	DRAWING UNITS: METER
PREPARED BY: AMTEL RESOURCES SDN BHD	INITIAL & DATE: -
DESIGNED BY: JEMI	INITIAL & DATE: -
CHECKED BY: FAZWAN	INITIAL & DATE: -
APPROVED BY: -	INITIAL & DATE: -

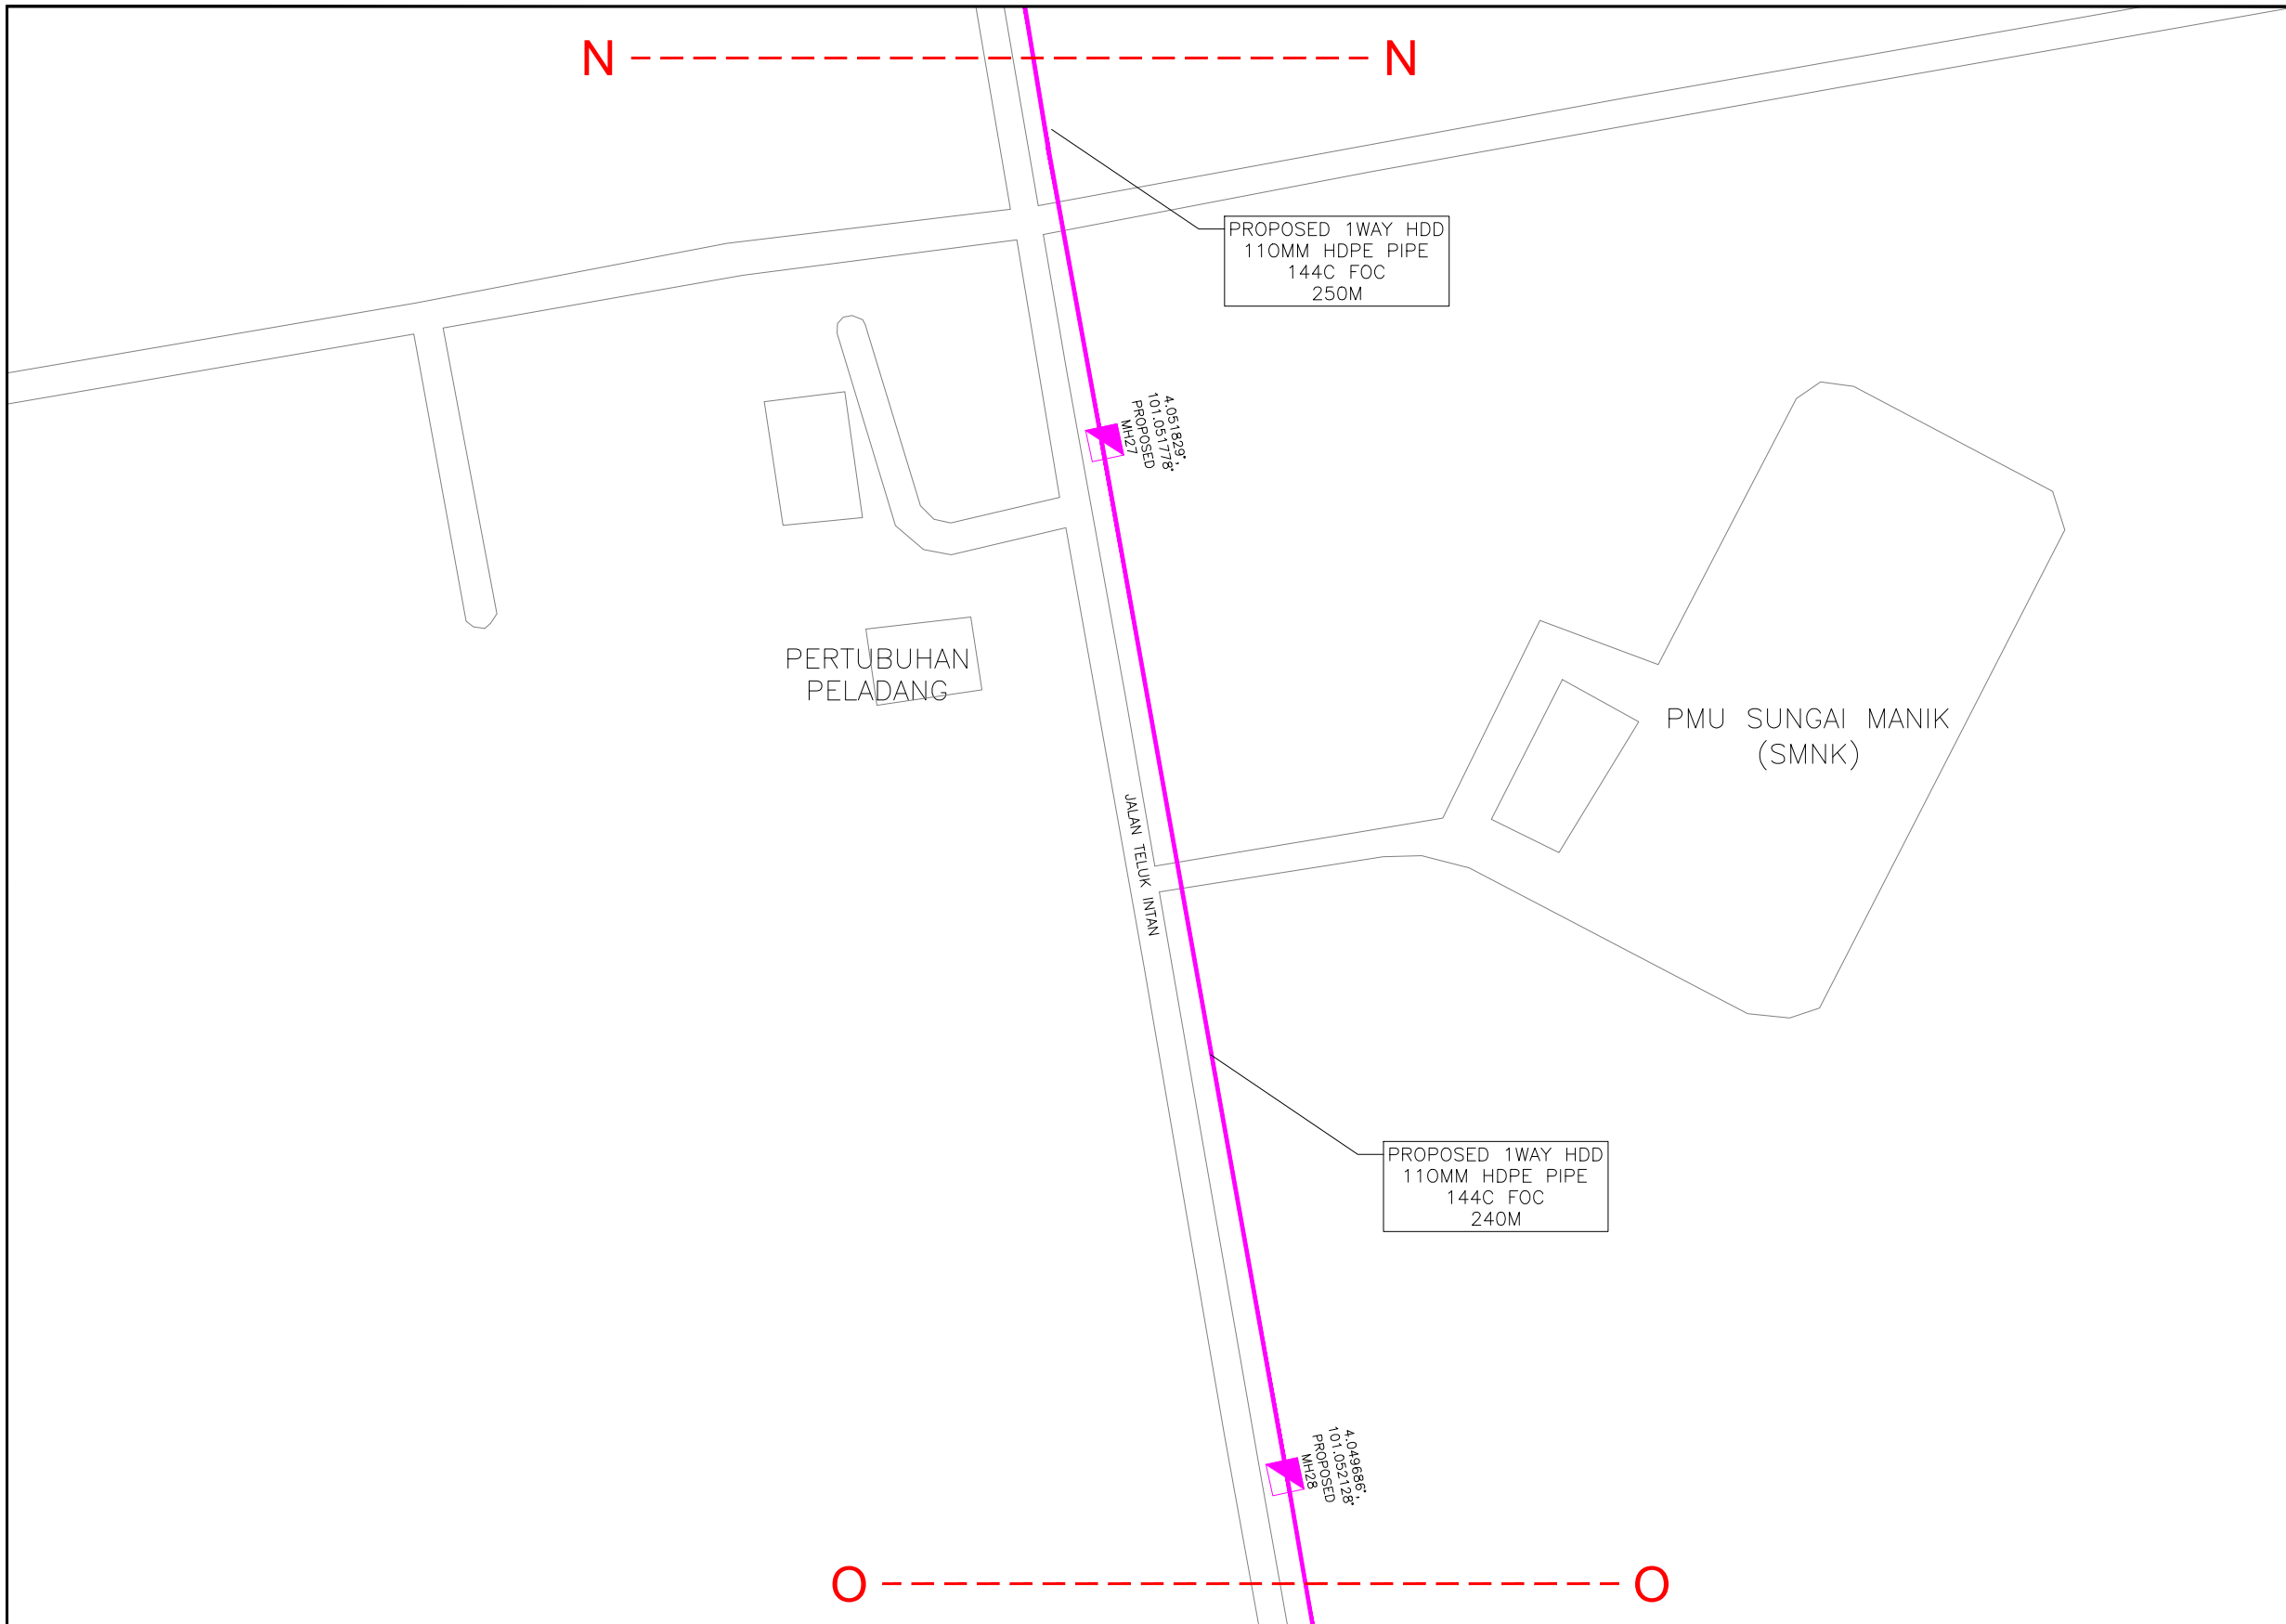

KELULUSAN PLAN

Local Authorities:-

CONFIDENTIALITY

These drawings and details are and shall remain the property of TT dotCom Sdn Bhd. Both are issued in strict confidence and shall not be reproduced, copied or used in any manner without specific written permission from the owner.

LEGEND :- OUTSIDE PLANT

- = BUILDING MANHOLE
- = BUILDING PIT
- = PROPOSED TIME MANHOLE
- = EXISTING TIME MANHOLE
- = PROPOSED TIME DUCT ROUTE
- = PROPOSED TIME DUCT TO BUILDING
- = EXISTING BUILDING DUCT ROUTE
- = EXISTING BUILDING CABLE TRAY
- = PROPOSED TRUNKING
- = PROPOSED CONDUIT
- = CLAIM AREA
- 1W / 2W = 1 WAY OR 2 WAY DUCT
- GI = GALVANISED IRON DUCT
- PVC = PVC DUCT
- = HIDDEN DRAIN
- = VISIBLE DRAIN
- = TREES AND PLANTS

REV. NO.	REV. DATE	REV. BY	DESCRIPTION:




TT dotCom Sdn Bhd (52371-A)  
 No 14, Jalan Majistret U1/26,  
 Hicom Glenmarie Industrial Park  
 40150 Shah Alam, Selangor Darul Ehsan, Malaysia.  
 Tel: +60 3 5032 6000  
 Website: www.time.com.my

PROJECT TITLE:  
 FTK NEW 1W UNDERGROUND CIVIL & 1X144F CABLE  
 PULLING INFRASTRUCTURE FROM  
 BIDOR – H.MELINTANG (PACKAGE 4)

DRAWING TITLE:  
 PROPOSED DRAWING  
 (PREVENTIVE MAINTENANCE WITH ANTI RODENT  
 144C FIBER)

DRAWING NO: TTdC/0000/UMOB/LEML/0001      SHEET NO: 31 OF 15

DRAWING SCALE: N.T.S	DRAWING UNITS: METER
PREPARED BY: AMTEL RESOURCES SDN BHD	INITIAL & DATE: -
DESIGNED BY: JEMI	INITIAL & DATE: -
CHECKED BY: FAZWAN	INITIAL & DATE: -
APPROVED BY: -	INITIAL & DATE: -

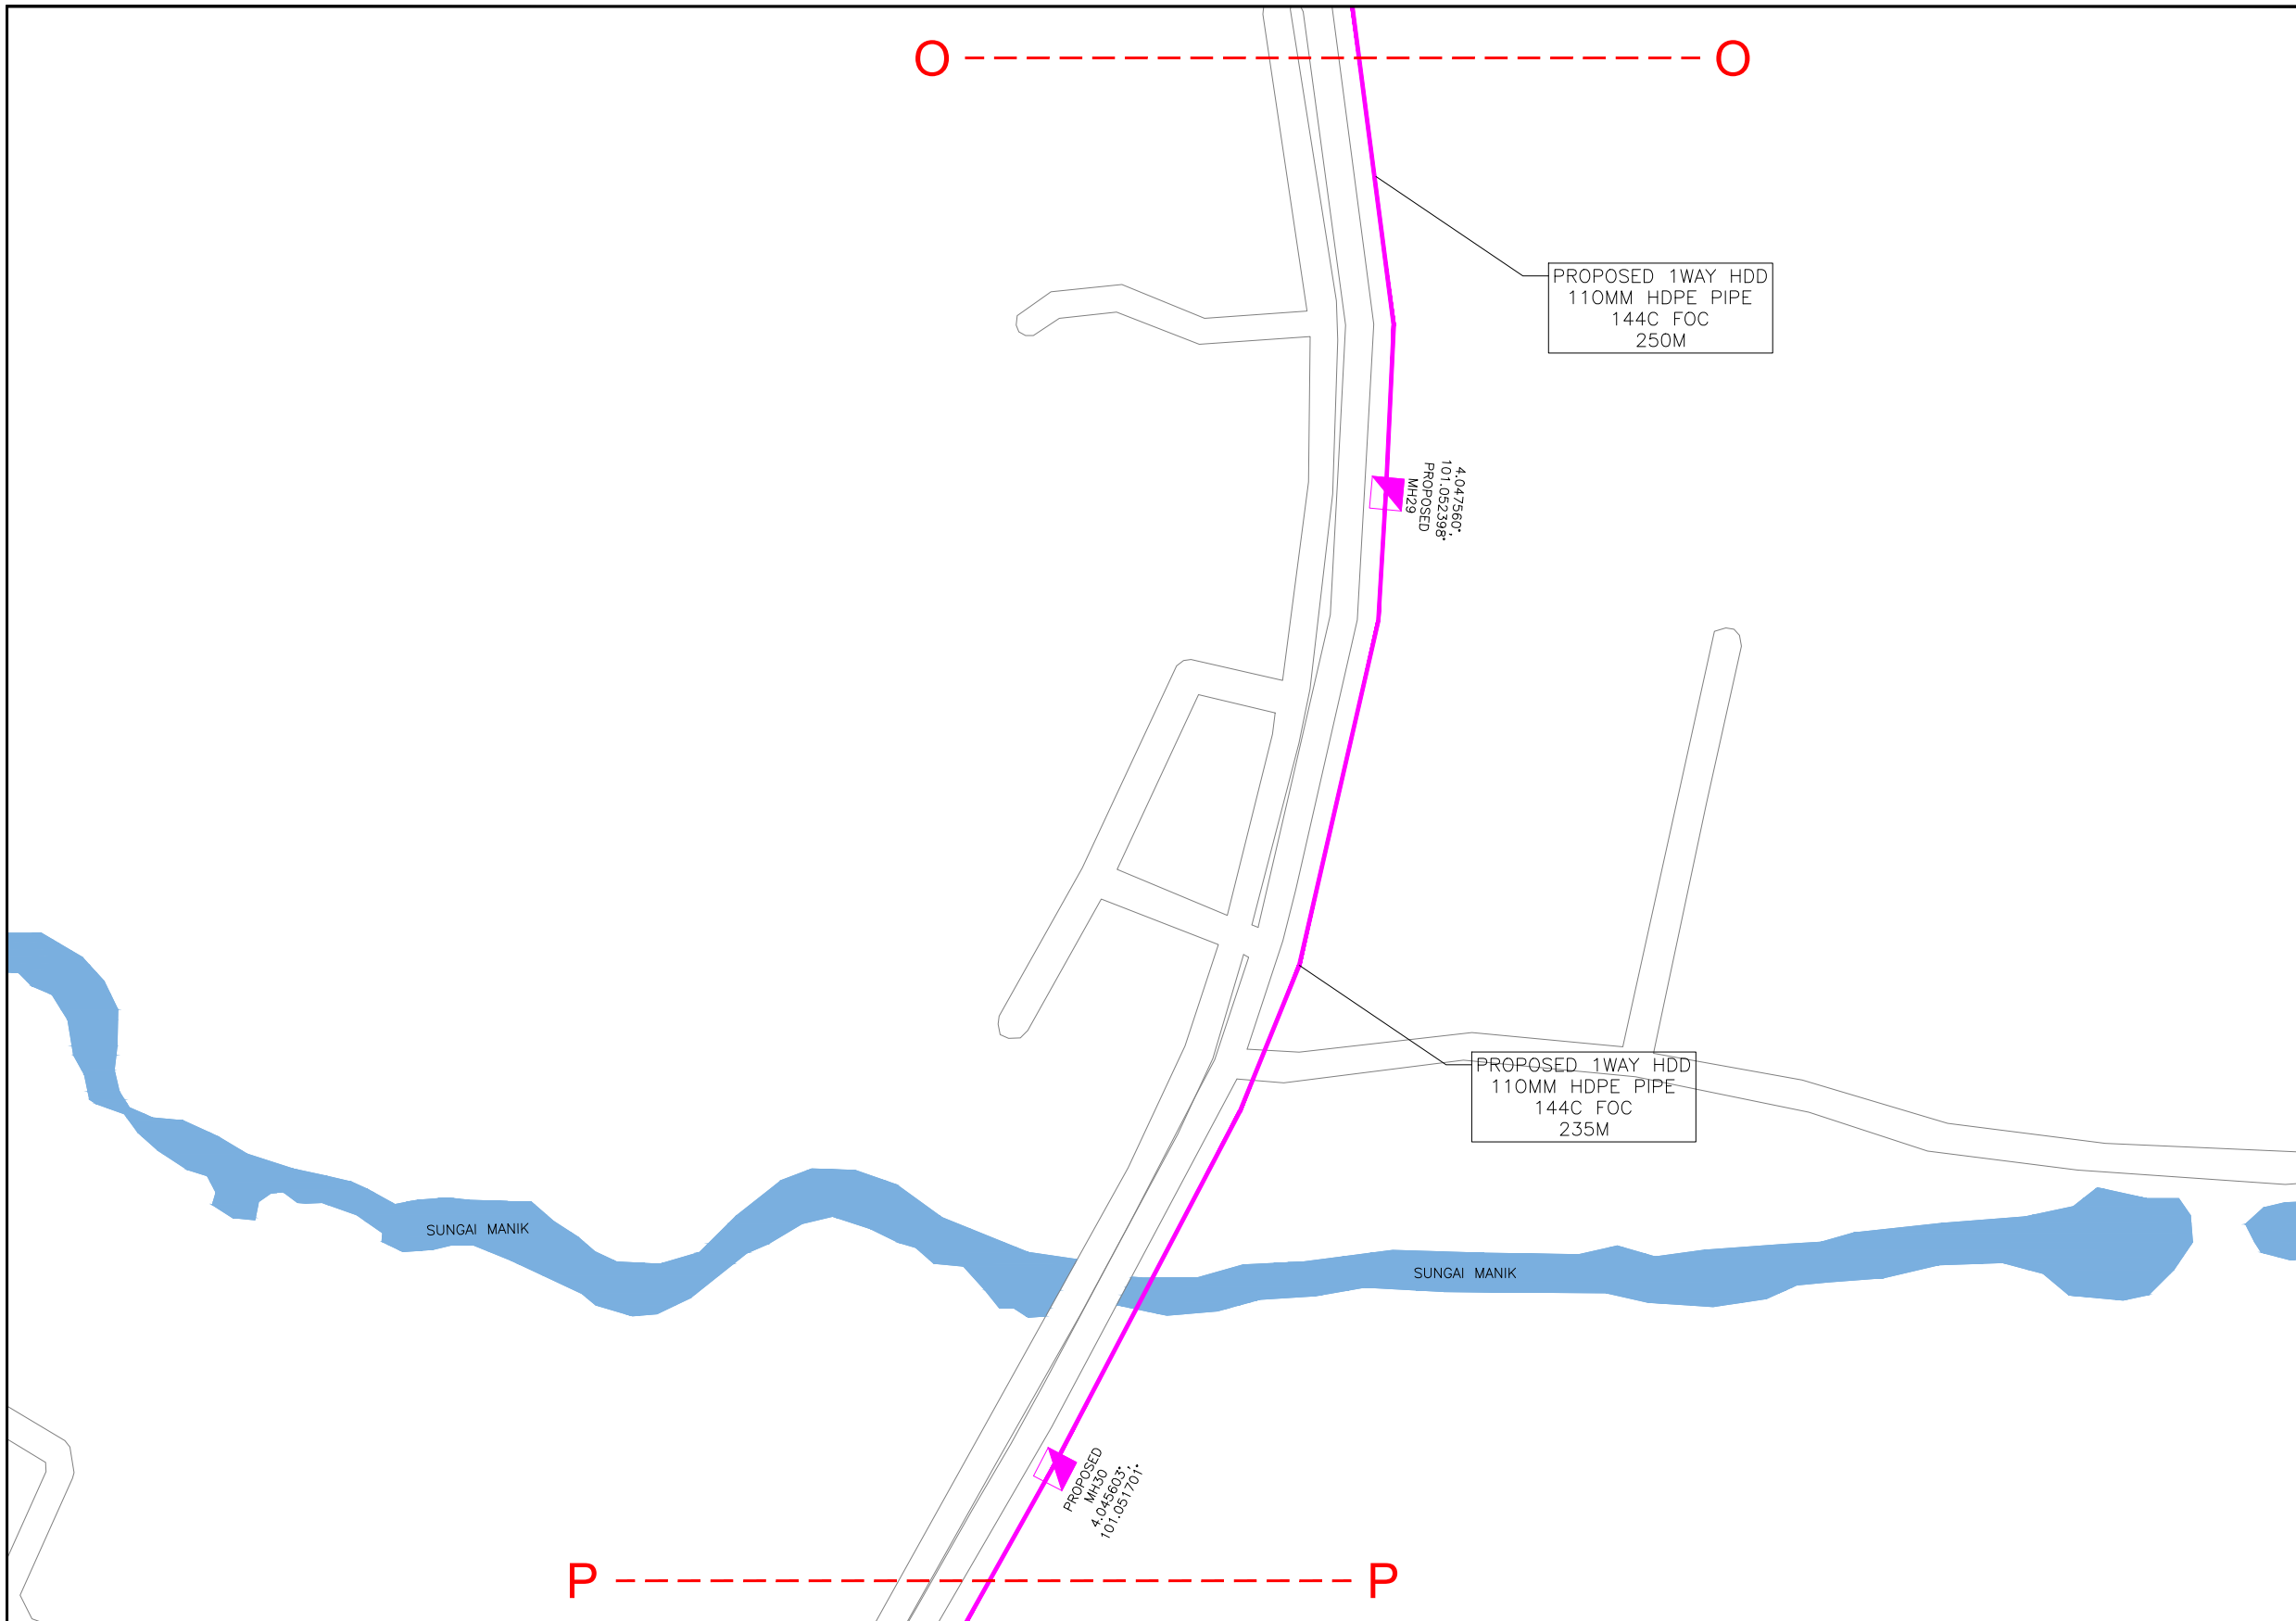

KELULUSAN PLAN

Local Authorities:-

CONFIDENTIALITY

These drawings and details are and shall remain the property of TT dotCom Sdn Bhd. Both are issued in strict confidence and shall not be reproduced, copied or used in any manner without specific written permission from the owner.

LEGEND :- OUTSIDE PLANT

- = BUILDING MANHOLE
- = BUILDING PIT
- = PROPOSED TIME MANHOLE
- = EXISTING TIME MANHOLE
- = PROPOSED TIME DUCT ROUTE
- = PROPOSED TIME DUCT TO BUILDING
- = EXISTING BUILDING DUCT ROUTE
- = EXISTING BUILDING CABLE TRAY
- = PROPOSED TRUNKING
- = PROPOSED CONDUIT
- = CLAIM AREA
- 1W / 2W = 1 WAY OR 2 WAY DUCT
- GI = GALVANISED IRON DUCT
- PVC = PVC DUCT
- = HIDDEN DRAIN
- = VISIBLE DRAIN
- = TREES AND PLANTS


REV. NO.	REV. DATE	REV. BY	DESCRIPTION:



TT dotCom Sdn Bhd (52371-A)  
 No 14, Jalan Majistret U1/26,  
 Hicom Glenmarie Industrial Park  
 40150 Shah Alam, Selangor Darul Ehsan, Malaysia.  
 Tel: +60 3 5032 6000  
 Website: www.time.com.my

PROJECT TITLE: FTK NEW 1W UNDERGROUND CIVIL & 1X144F CABLE PULLING INFRASTRUCTURE FROM BIDOR – H.MELINTANG (PACKAGE 4)	
DRAWING TITLE: PROPOSED DRAWING (PREVENTIVE MAINTENANCE WITH ANTI RODENT 144C FIBER)	
DRAWING NO: TTdC/0000/UMOB/LEML/0001	SHEET NO: 31 OF 16

DRAWING SCALE: N.T.S	DRAWING UNITS: METER
PREPARED BY: AMTEL RESOURCES SDN BHD	INITIAL & DATE: -
DESIGNED BY: JEMI	INITIAL & DATE: -
CHECKED BY: FAZWAN	INITIAL & DATE: -
APPROVED BY: -	INITIAL & DATE: -

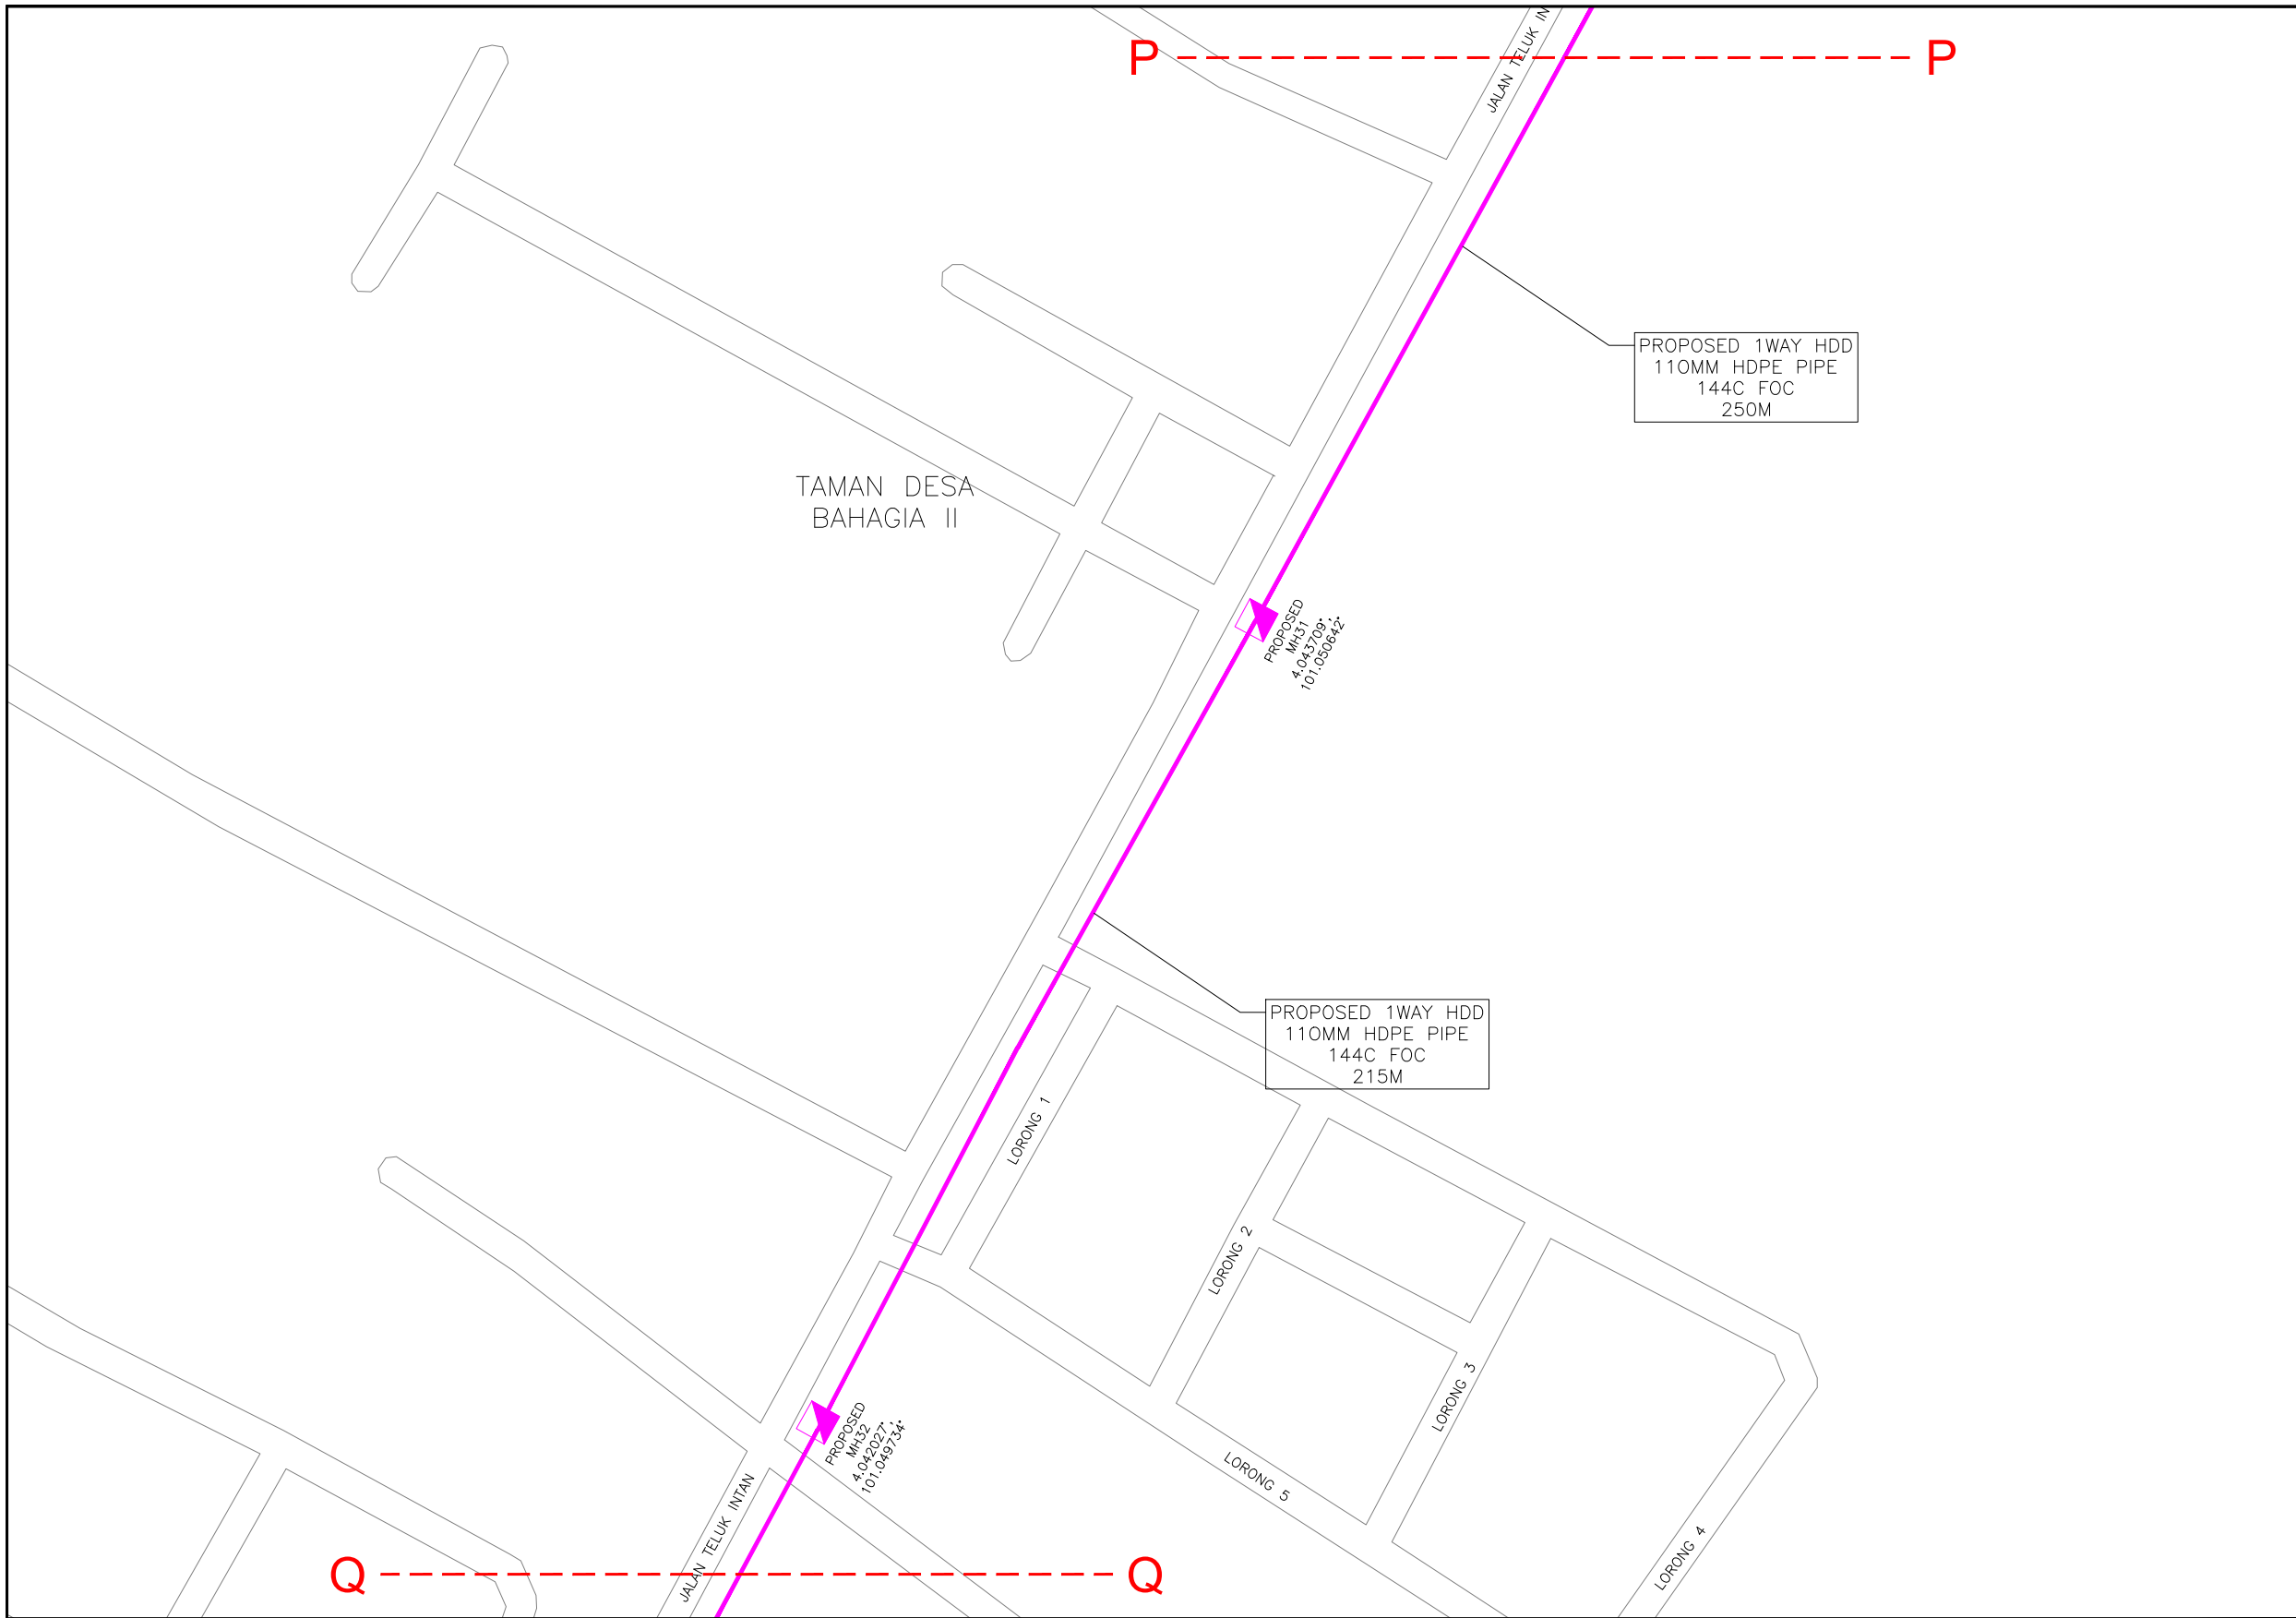

KELULUSAN PLAN

Local Authorities:-

CONFIDENTIALITY

These drawings and details are and shall remain the property of TT dotCom Sdn Bhd. Both are issued in strict confidence and shall not be reproduced, copied or used in any manner without specific written permission from the owner.

LEGEND :- OUTSIDE PLANT

- = BUILDING MANHOLE
- = BUILDING PIT
- = PROPOSED TIME MANHOLE
- = EXISTING TIME MANHOLE
- = PROPOSED TIME DUCT ROUTE
- = PROPOSED TIME DUCT TO BUILDING
- = EXISTING BUILDING DUCT ROUTE
- = EXISTING BUILDING CABLE TRAY
- = PROPOSED TRUNKING
- = PROPOSED CONDUIT
- = CLAIM AREA
- 1W / 2W = 1 WAY OR 2 WAY DUCT
- GI = GALVANISED IRON DUCT
- PVC = PVC DUCT
- = HIDDEN DRAIN
- = VISIBLE DRAIN
- = TREES AND PLANTS


REV. NO.	REV. DATE	REV. BY	DESCRIPTION:



TT dotCom Sdn Bhd (52371-A)  
 No 14, Jalan Majistret U1/26,  
 Hicom Glenmarie Industrial Park  
 40150 Shah Alam, Selangor Darul Ehsan, Malaysia.  
 Tel: +60 3 5032 6000  
 Website: www.time.com.my

PROJECT TITLE: FTK NEW 1W UNDERGROUND CIVIL & 1X144F CABLE PULLING INFRASTRUCTURE FROM BIDOR – H.MELINTANG (PACKAGE 4)
DRAWING TITLE: PROPOSED DRAWING (PREVENTIVE MAINTENANCE WITH ANTI RODENT 144C FIBER)
DRAWING NO: TTdC/0000/UMOB/LEML/0001
SHEET NO: 31 OF 17

DRAWING SCALE: N.T.S	DRAWING UNITS: METER
PREPARED BY: AMTEL RESOURCES SDN BHD	INITIAL & DATE: -
DESIGNED BY: JEMI	INITIAL & DATE: -
CHECKED BY: FAZWAN	INITIAL & DATE: -
APPROVED BY: -	INITIAL & DATE: -

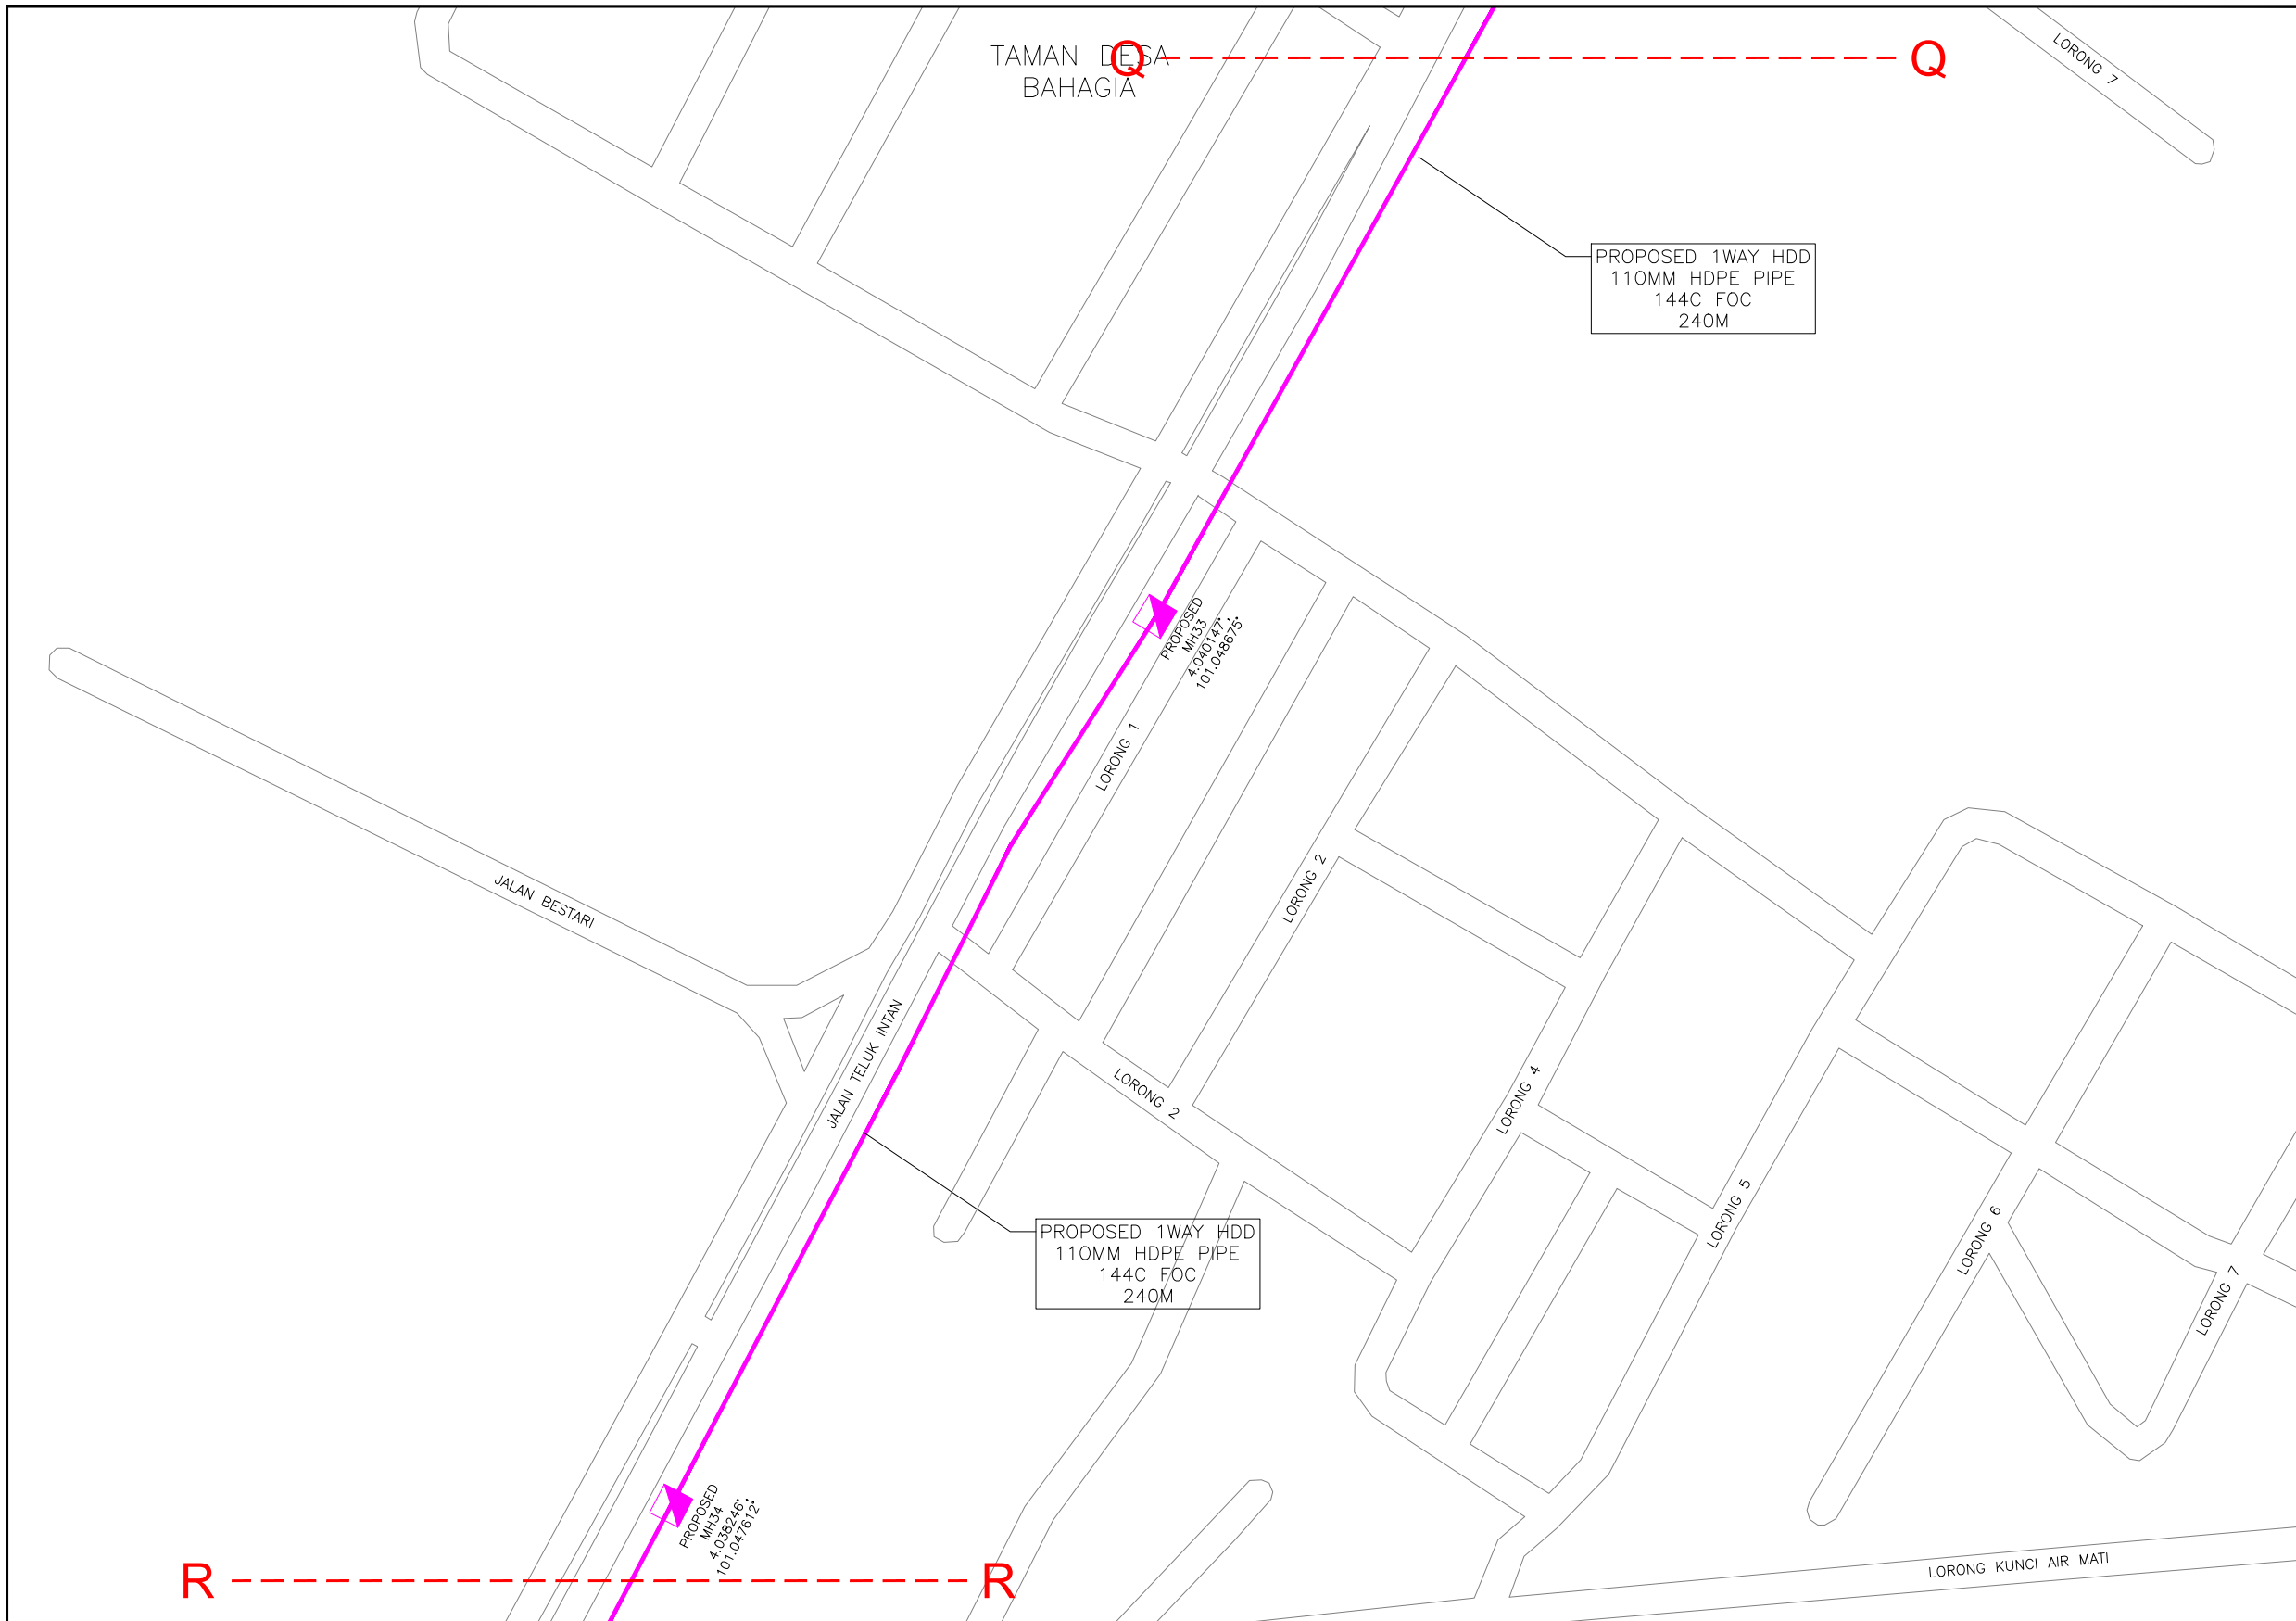

KELULUSAN PLAN

Local Authorities:-

CONFIDENTIALITY

These drawings and details are and shall remain the property of TT dotCom Sdn Bhd. Both are issued in strict confidence and shall not be reproduced, copied or used in any manner without specific written permission from the owner.

LEGEND :- OUTSIDE PLANT

- = BUILDING MANHOLE
- = BUILDING PIT
- = PROPOSED TIME MANHOLE
- = EXISTING TIME MANHOLE
- = PROPOSED TIME DUCT ROUTE
- = PROPOSED TIME DUCT TO BUILDING
- = EXISTING BUILDING DUCT ROUTE
- = EXISTING BUILDING CABLE TRAY
- = PROPOSED TRUNKING
- = PROPOSED CONDUIT
- = CLAIM AREA
- 1W / 2W = 1 WAY OR 2 WAY DUCT
- GI = GALVANISED IRON DUCT
- PVC = PVC DUCT
- = HIDDEN DRAIN
- = VISIBLE DRAIN
- = TREES AND PLANTS

REV. NO.	REV. DATE	REV. BY	DESCRIPTION:



TT dotCom Sdn Bhd (52371-A)  
No 14, Jalan Majistret U1/26,  
Hicom Glenmarie Industrial Park  
40150 Shah Alam, Selangor Darul Ehsan, Malaysia.  
Tel: +60 3 5032 6000  
Website: www.time.com.my


PROJECT TITLE:  
FTK NEW 1W UNDERGROUND CIVIL & 1X144F CABLE PULLING INFRASTRUCTURE FROM BIDOR – H.MELINTANG (PACKAGE 4)

DRAWING TITLE:  
PROPOSED DRAWING  
(PREVENTIVE MAINTENANCE WITH ANTI RODENT 144C FIBER)

DRAWING NO: TTdC/0000/UMOB/LEML/0001

SHEET NO: 31 OF 18

DRAWING SCALE: N.T.S	DRAWING UNITS: METER
PREPARED BY: AMTEL RESOURCES SDN BHD	INITIAL & DATE: -
DESIGNED BY: JEMI	INITIAL & DATE: -
CHECKED BY: FAZWAN	INITIAL & DATE: -
APPROVED BY: -	INITIAL & DATE: -

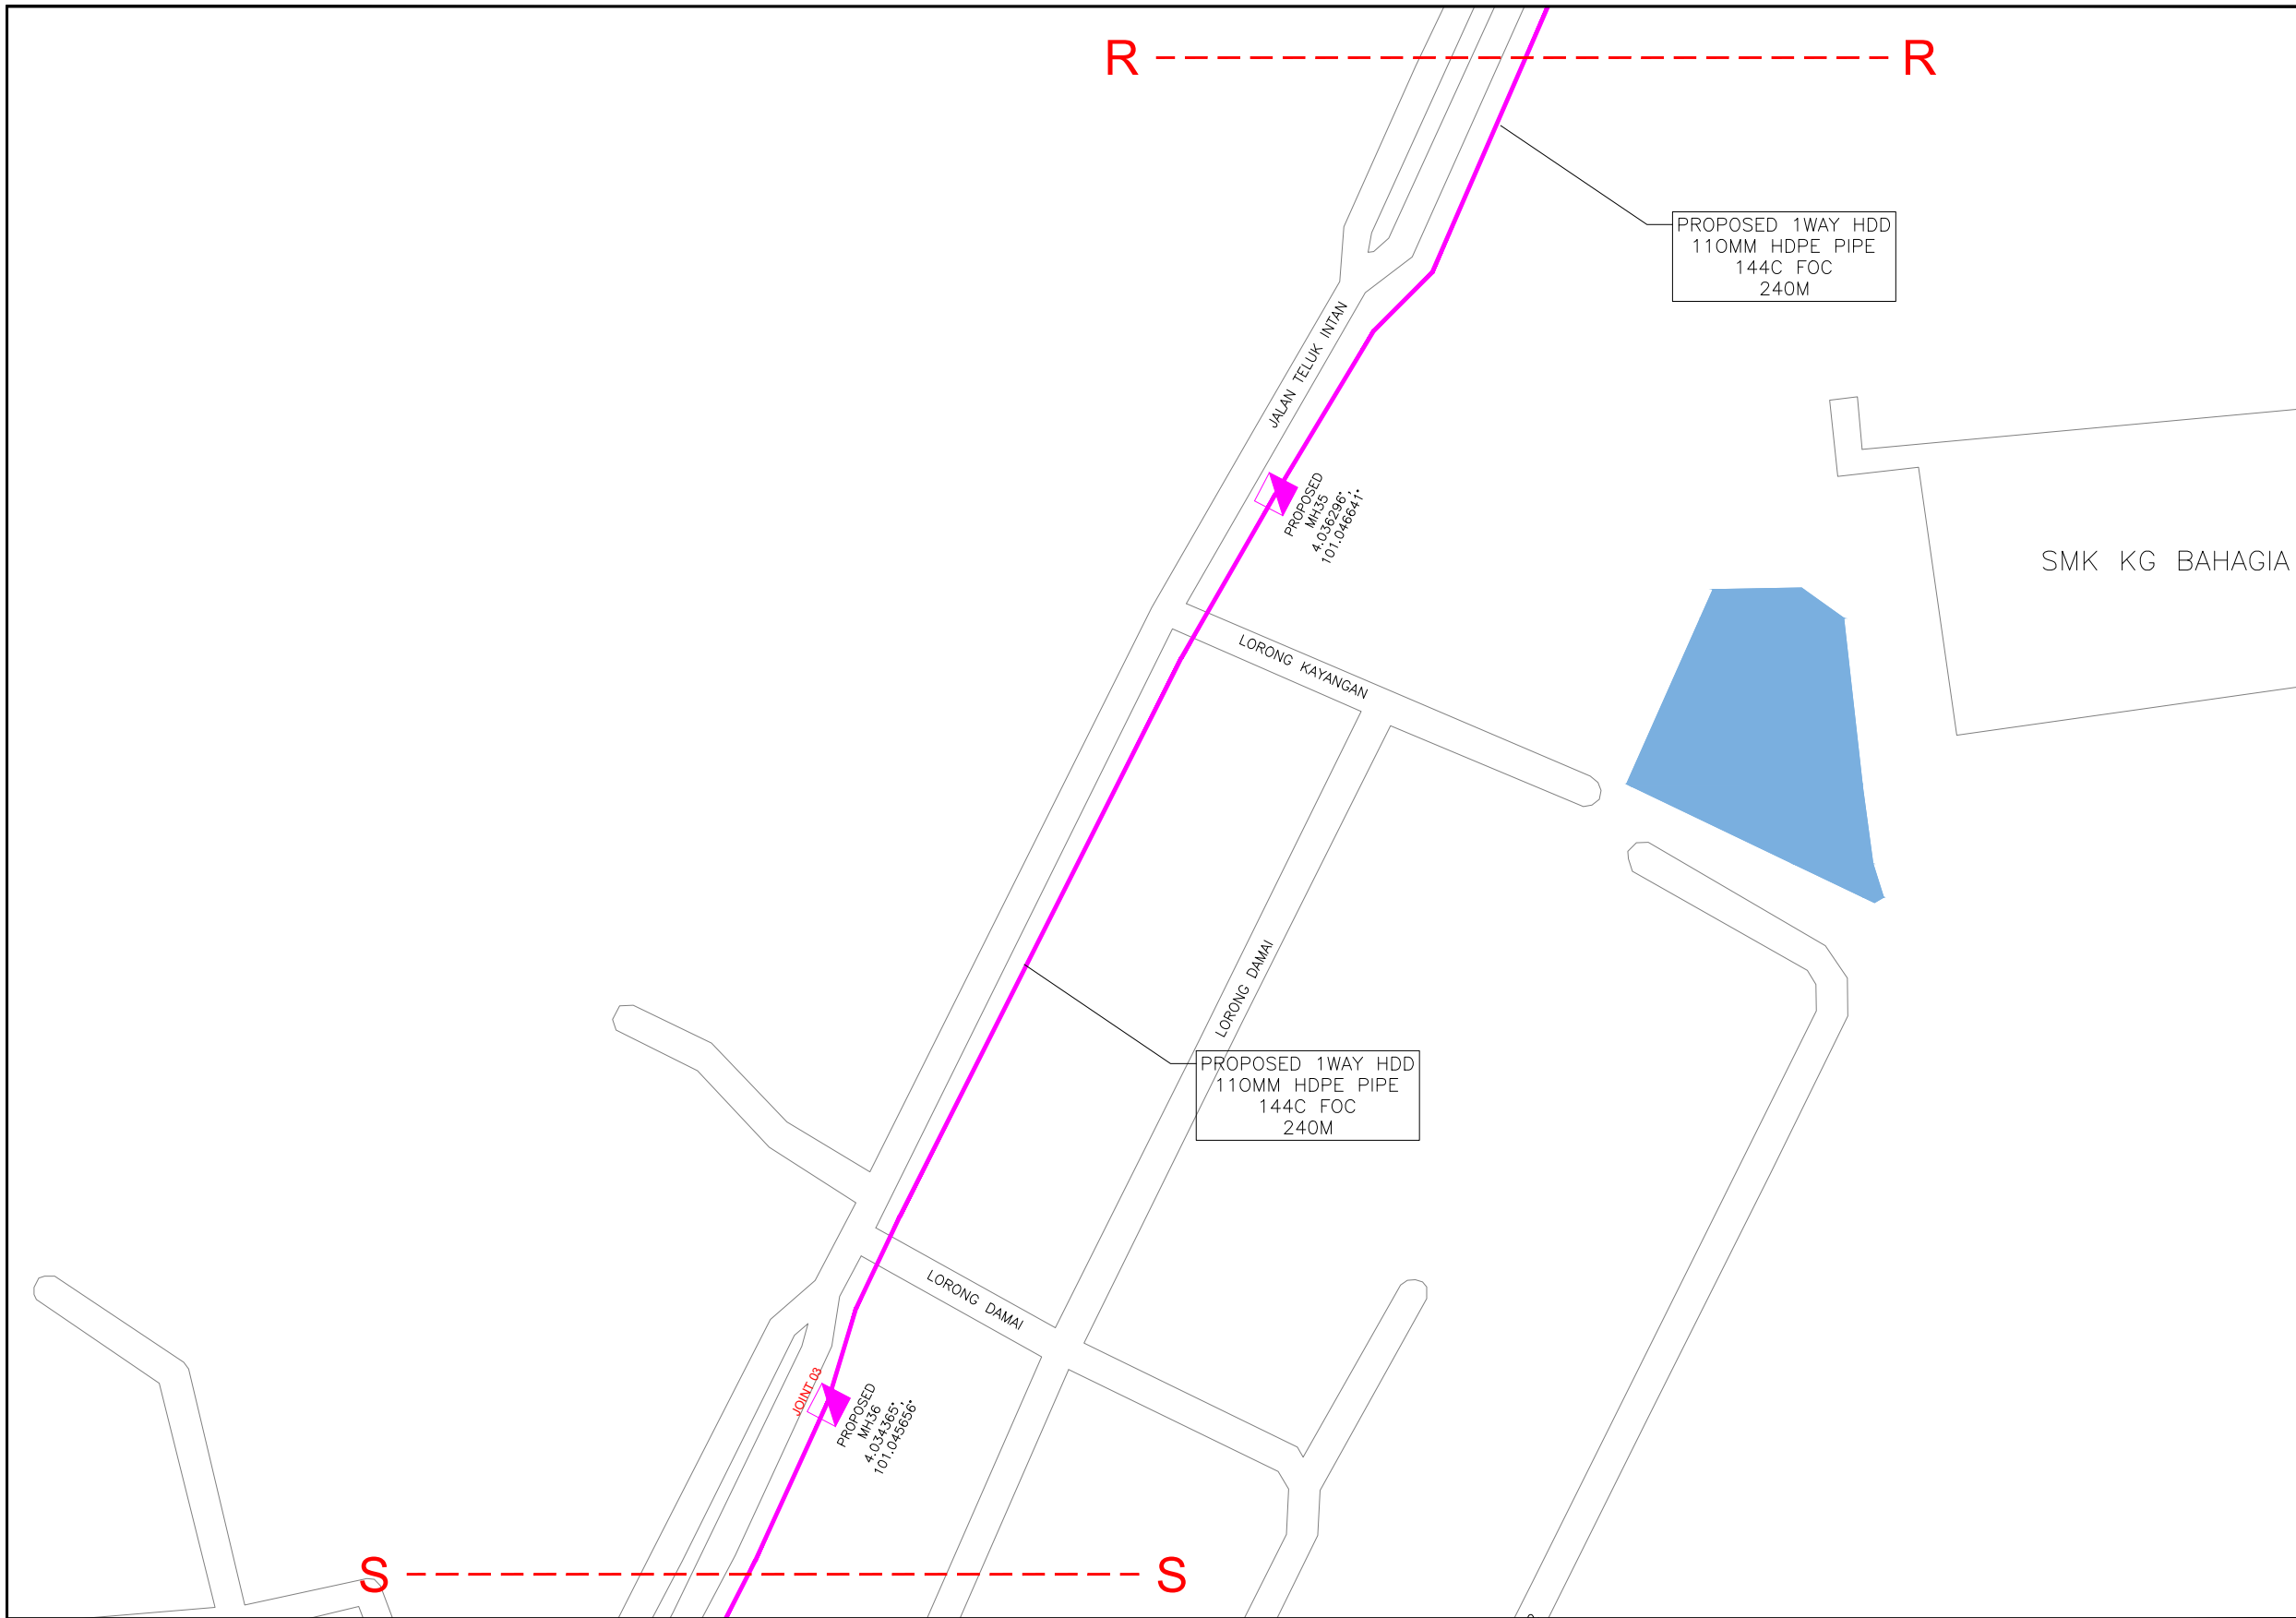

KELULUSAN PLAN

Local Authorities:-

CONFIDENTIALITY

These drawings and details are and shall remain the property of TT dotCom Sdn Bhd. Both are issued in strict confidence and shall not be reproduced, copied or used in any manner without specific written permission from the owner.

LEGEND :- OUTSIDE PLANT

- = BUILDING MANHOLE
- = BUILDING PIT
- = PROPOSED TIME MANHOLE
- = EXISTING TIME MANHOLE
- = PROPOSED TIME DUCT ROUTE
- = PROPOSED TIME DUCT TO BUILDING
- = EXISTING BUILDING DUCT ROUTE
- = EXISTING BUILDING CABLE TRAY
- = PROPOSED TRUNKING
- = PROPOSED CONDUIT
- = CLAIM AREA
- 1W / 2W = 1 WAY OR 2 WAY DUCT
- GI = GALVANISED IRON DUCT
- PVC = PVC DUCT
- = HIDDEN DRAIN
- = VISIBLE DRAIN
- = TREES AND PLANTS


REV. NO.	REV. DATE	REV. BY	DESCRIPTION:



TT dotCom Sdn Bhd (52371-A)  
 No 14, Jalan Majistret U1/26,  
 Hicom Glenmarie Industrial Park  
 40150 Shah Alam, Selangor Darul Ehsan, Malaysia.  
 Tel: +60 3 5032 6000  
 Website: www.time.com.my

PROJECT TITLE: FTK NEW 1W UNDERGROUND CIVIL & 1X144F CABLE PULLING INFRASTRUCTURE FROM BIDOR – H.MELINTANG (PACKAGE 4)	
DRAWING TITLE: PROPOSED DRAWING (PREVENTIVE MAINTENANCE WITH ANTI RODENT 144C FIBER)	
DRAWING NO: TTdC/0000/UMOB/LEML/0001	SHEET NO: 31 OF 19

DRAWING SCALE: N.T.S	DRAWING UNITS: METER
PREPARED BY: AMTEL RESOURCES SDN BHD	INITIAL & DATE: -
DESIGNED BY: JEMI	INITIAL & DATE: -
CHECKED BY: FAZWAN	INITIAL & DATE: -
APPROVED BY: -	INITIAL & DATE: -

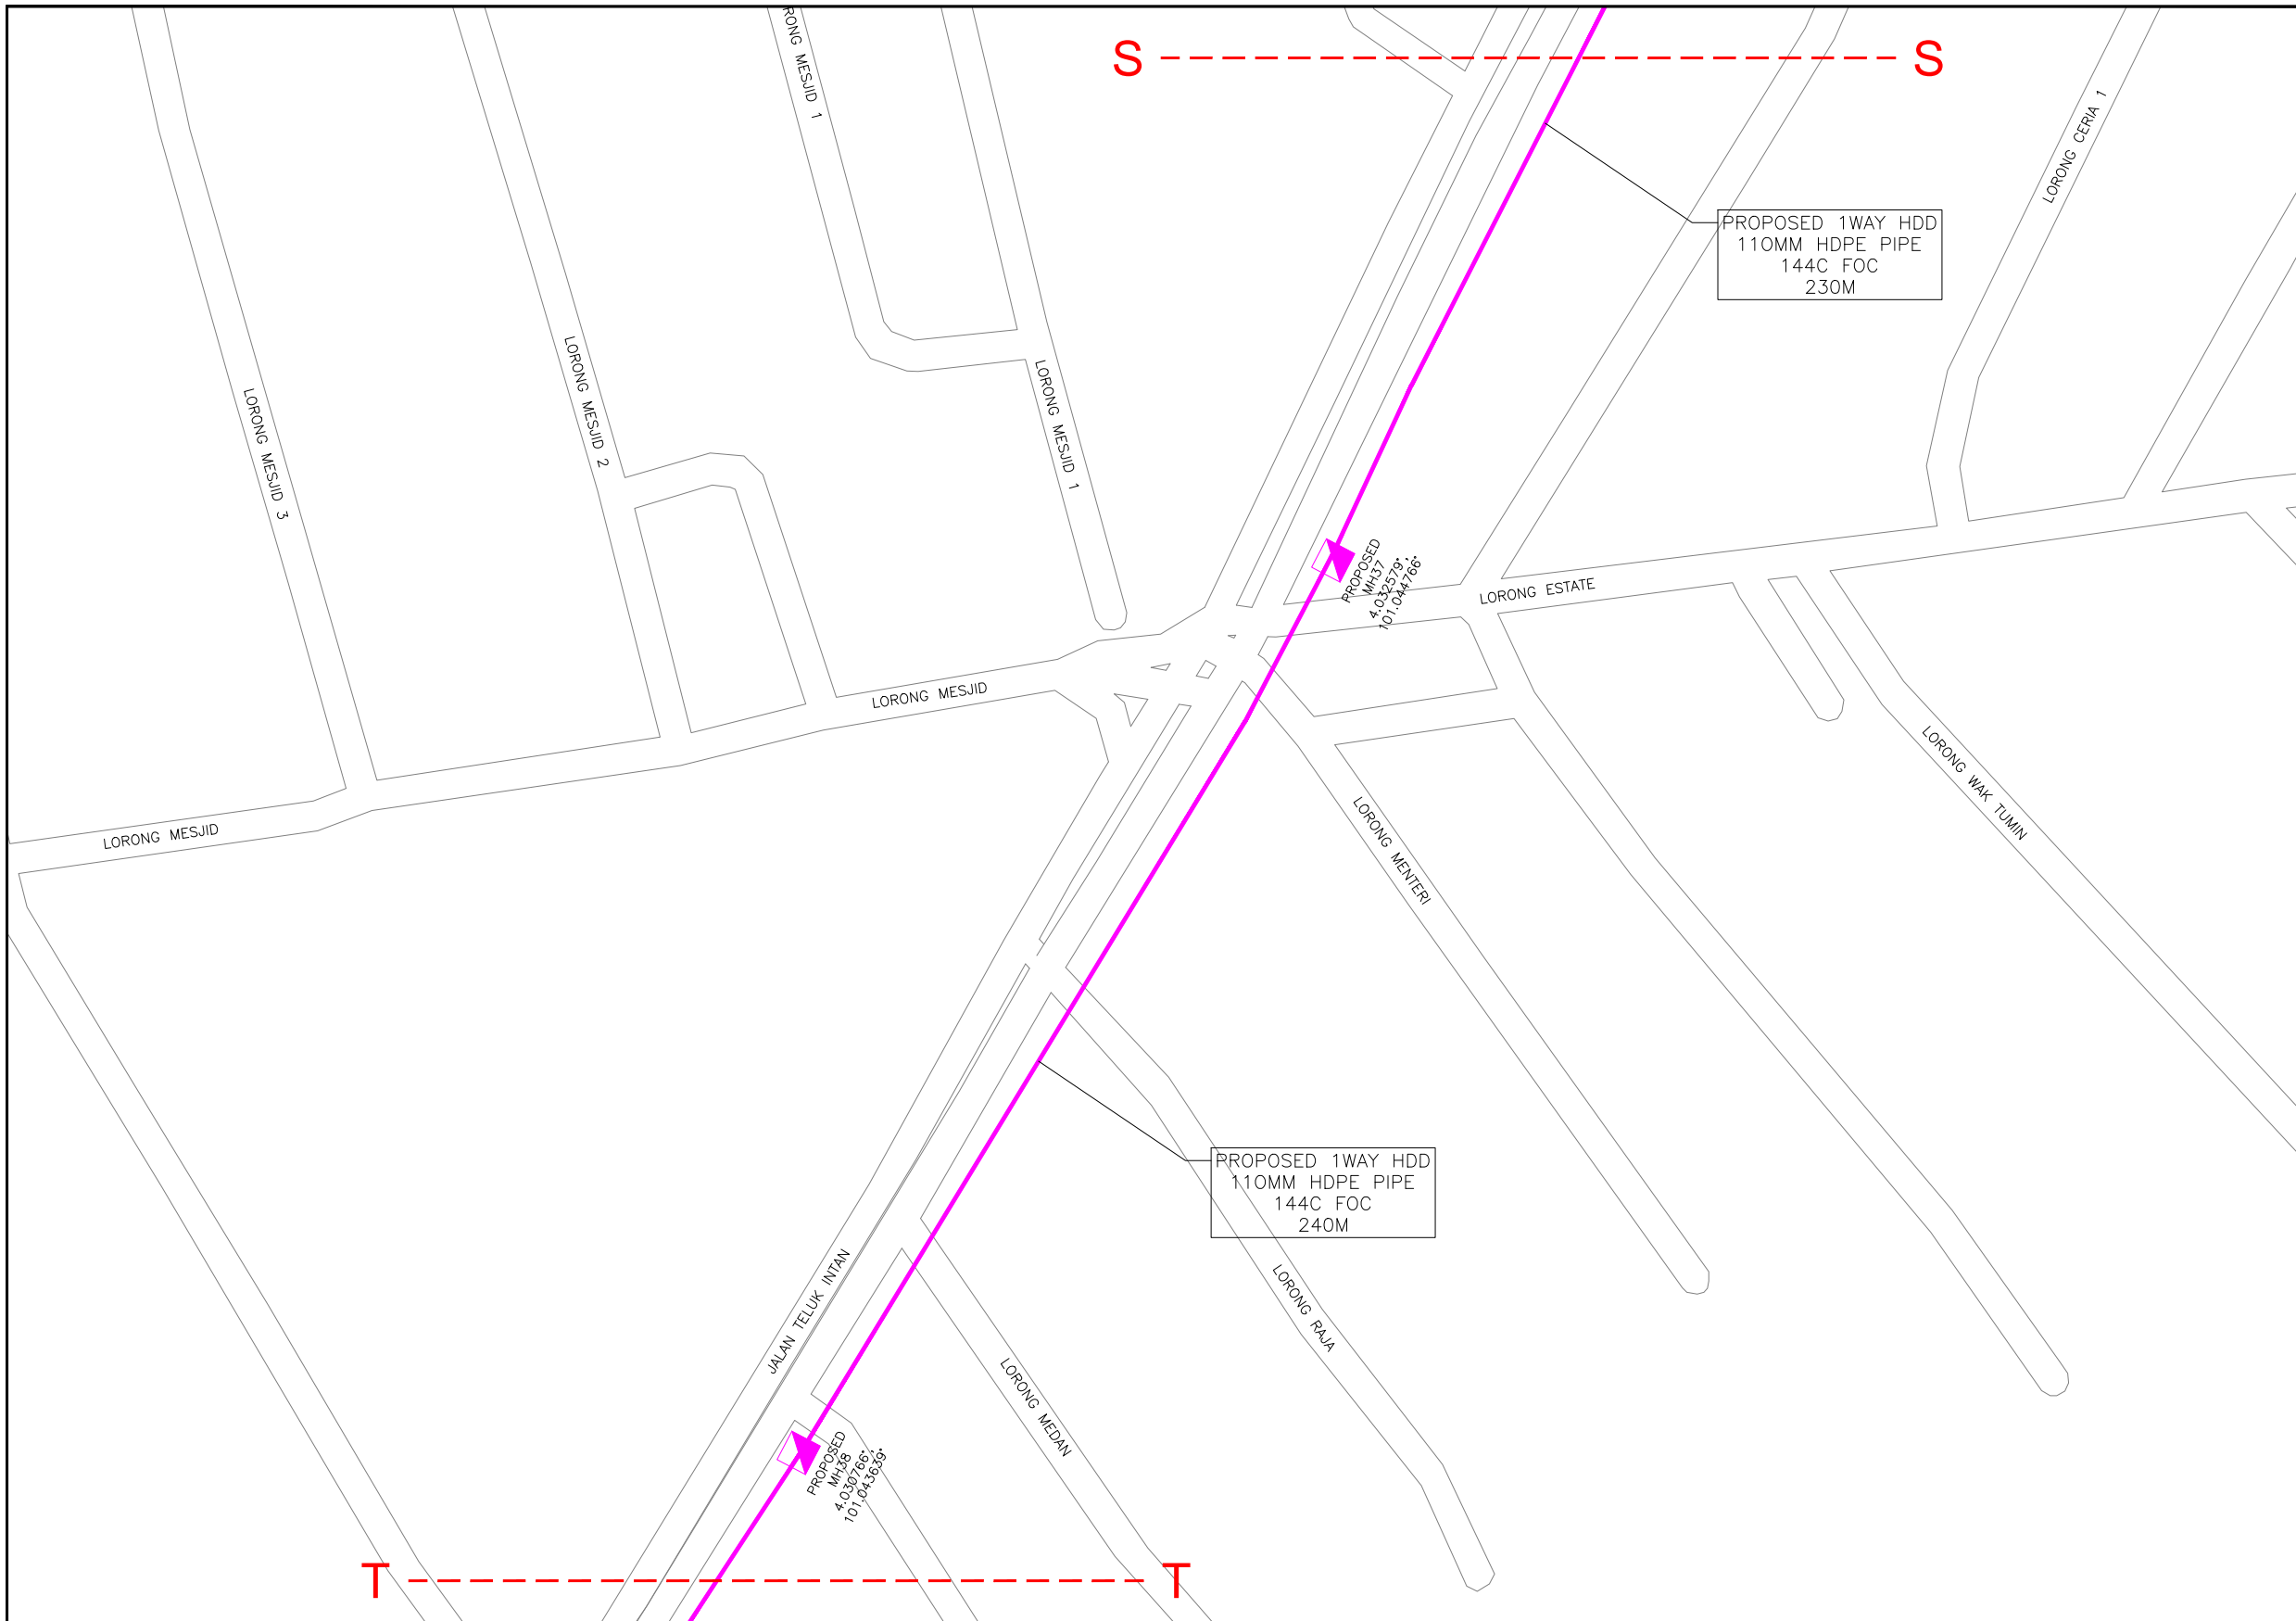

KELULUSAN PLAN

Local Authorities:-

CONFIDENTIALITY

These drawings and details are and shall remain the property of TT dotCom Sdn Bhd. Both are issued in strict confidence and shall not be reproduced, copied or used in any manner without specific written permission from the owner.

LEGEND :- OUTSIDE PLANT


- = BUILDING MANHOLE
- = BUILDING PIT
- = PROPOSED TIME MANHOLE
- = EXISTING TIME MANHOLE
- = PROPOSED TIME DUCT ROUTE
- = PROPOSED TIME DUCT TO BUILDING
- = EXISTING BUILDING DUCT ROUTE
- = EXISTING BUILDING CABLE TRAY
- = PROPOSED TRUNKING
- = PROPOSED CONDUIT
- = CLAIM AREA
- 1W / 2W = 1 WAY OR 2 WAY DUCT
- GI = GALVANISED IRON DUCT
- PVC = PVC DUCT
- = HIDDEN DRAIN
- = VISIBLE DRAIN
- = TREES AND PLANTS

REV. NO.	REV. DATE	REV. BY	DESCRIPTION:



TT dotCom Sdn Bhd (52371-A)  
 No 14, Jalan Majistret U1/26,  
 Hicom Glenmarie Industrial Park  
 40150 Shah Alam, Selangor Darul Ehsan, Malaysia.  
 Tel: +60 3 5032 6000  
 Website: www.time.com.my

PROJECT TITLE: FTK NEW 1W UNDERGROUND CIVIL & 1X144F CABLE PULLING INFRASTRUCTURE FROM BIDOR – H.MELINTANG (PACKAGE 4)	DRAWING SCALE: N.T.S	DRAWING UNITS: METER
DRAWING TITLE: PROPOSED DRAWING (PREVENTIVE MAINTENANCE WITH ANTI RODENT 144C FIBER)	PREPARED BY: AMTEL RESOURCES SDN BHD	INITIAL & DATE: -
DRAWING NO: TTdC/0000/UMOB/LEML/0001	DESIGNED BY: JEMI	INITIAL & DATE: -
SHEET NO: 31 OF 20	CHECKED BY: FAZWAN	INITIAL & DATE: -
	APPROVED BY: -	INITIAL & DATE: -

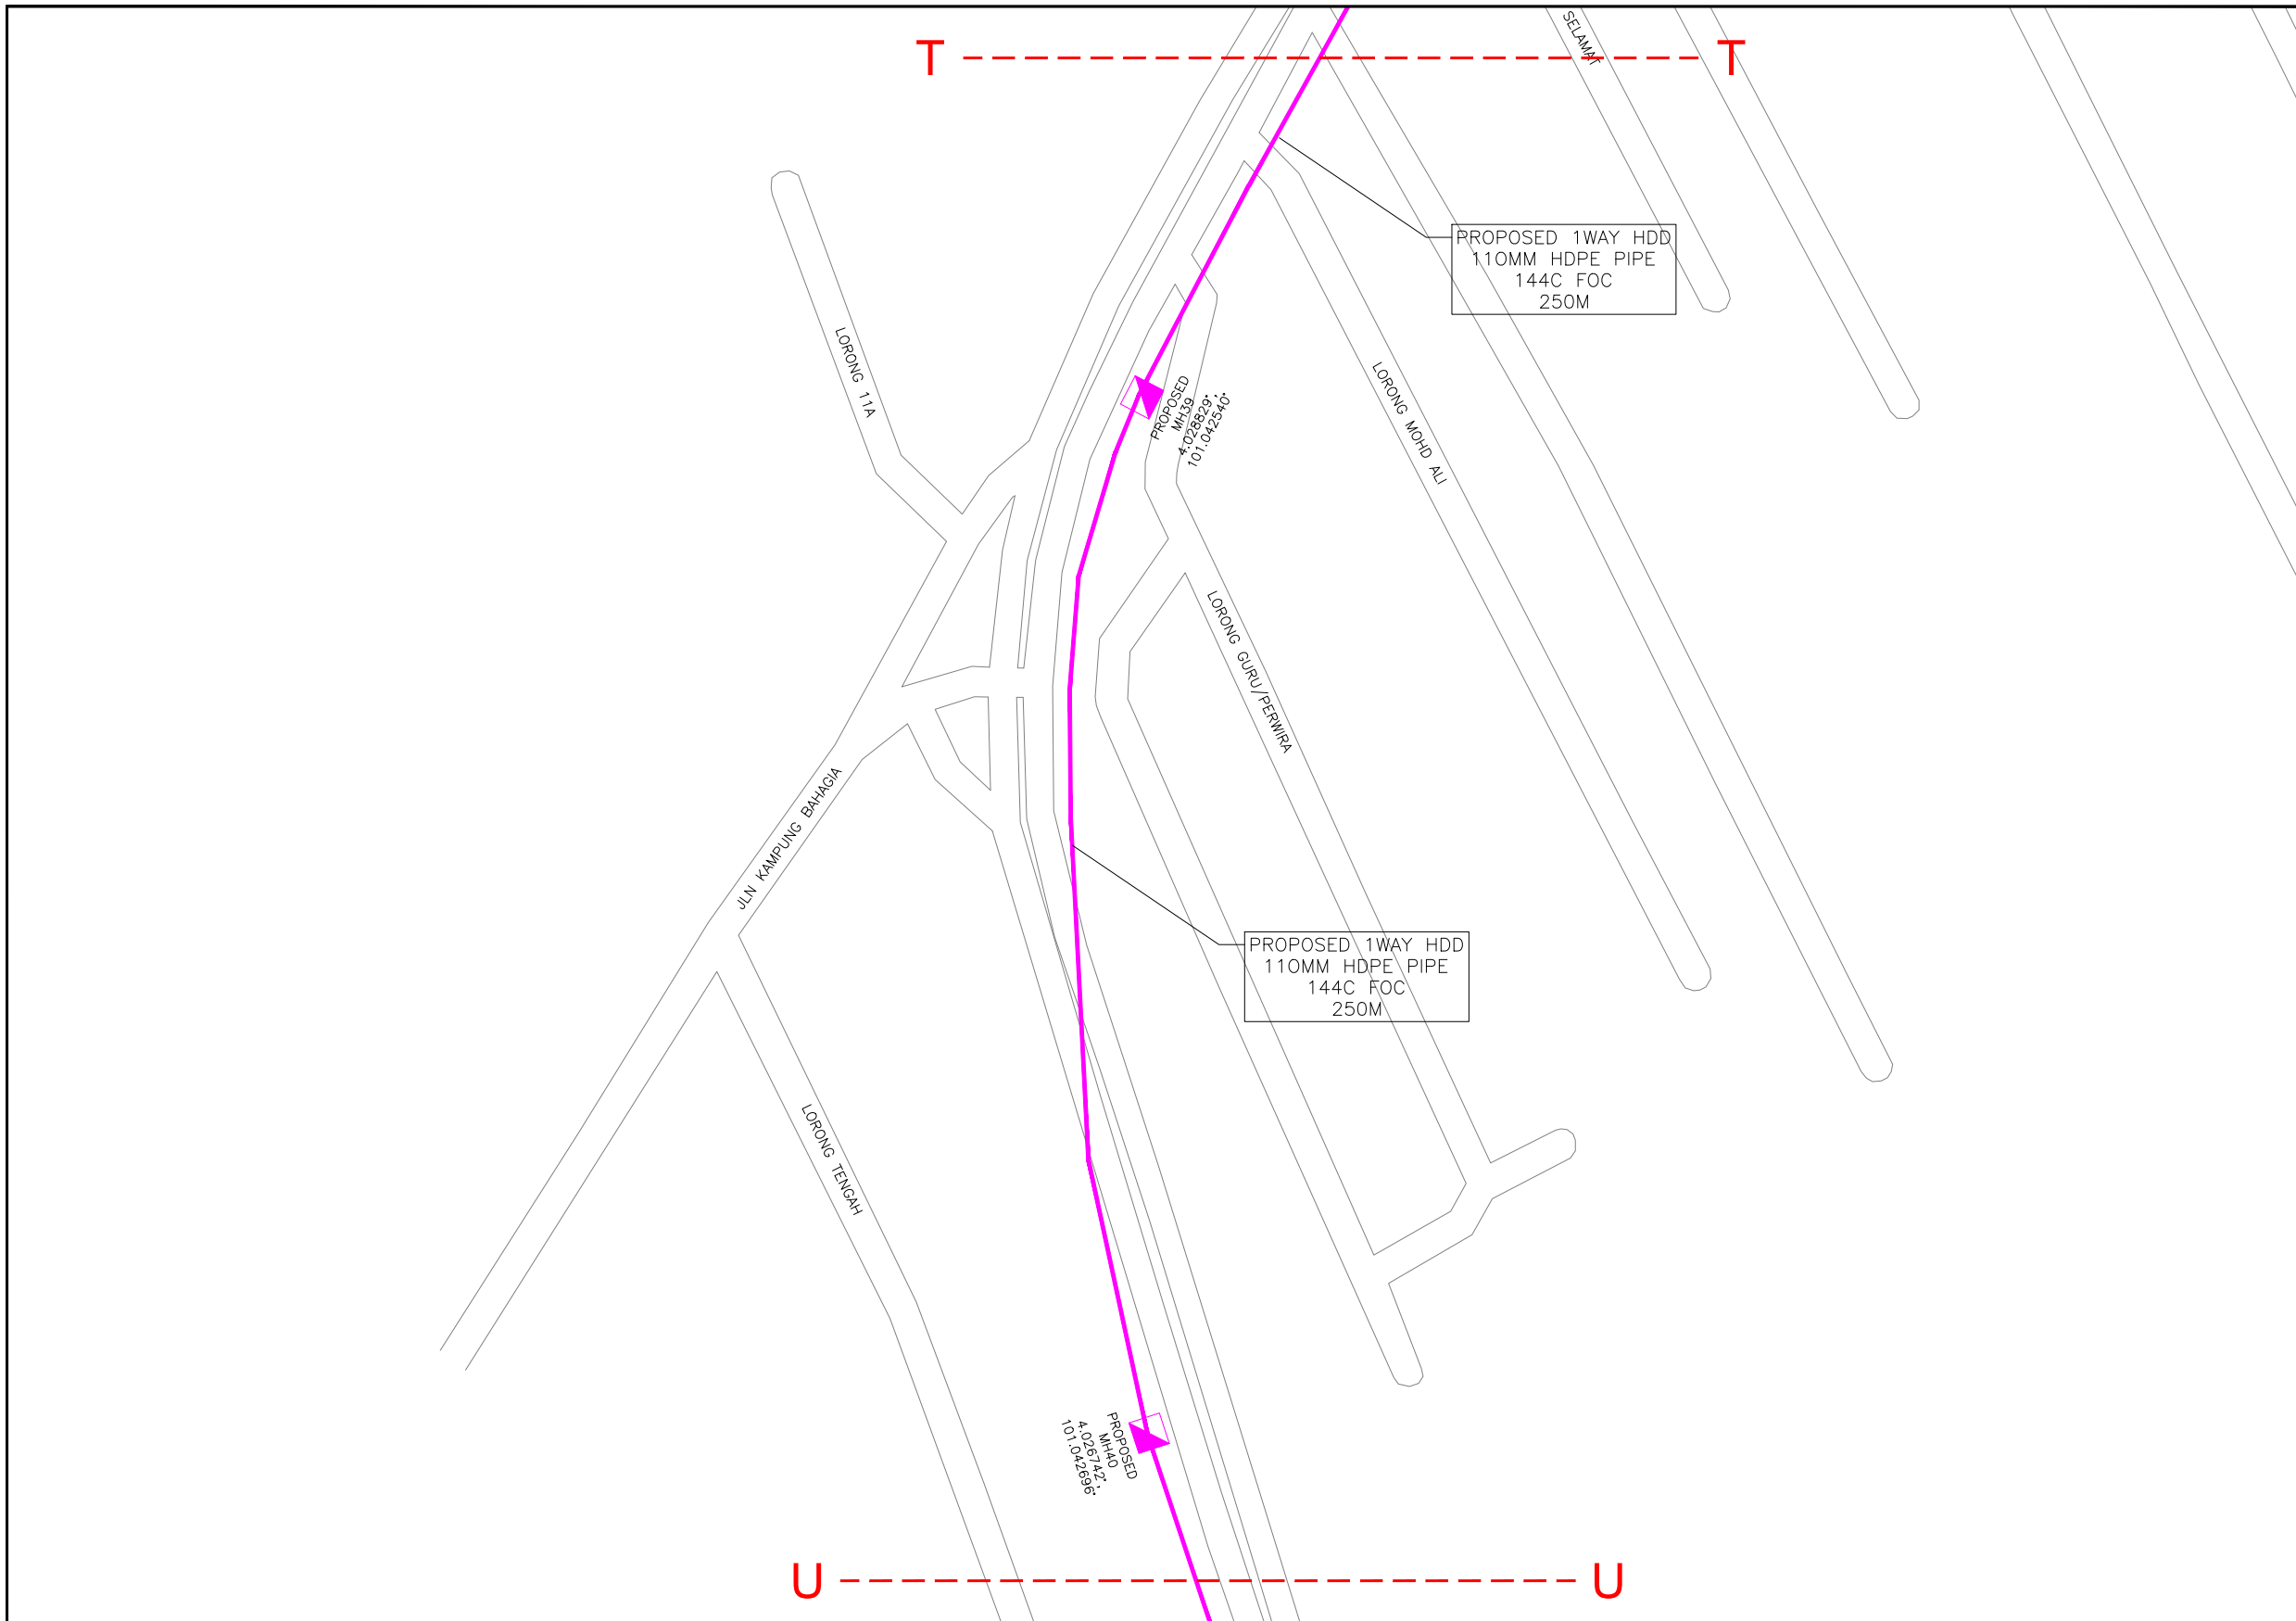

KELULUSAN PLAN

Local Authorities:--

CONFIDENTIALITY

These drawings and details are and shall remain the property of TT dotCom Sdn Bhd. Both are issued in strict confidence and shall not be reproduced, copied or used in any manner without specific written permission from the owner.

LEGEND :- OUTSIDE PLANT

- = BUILDING MANHOLE
- = BUILDING PIT
- = PROPOSED TIME MANHOLE
- = EXISTING TIME MANHOLE
- = PROPOSED TIME DUCT ROUTE
- = PROPOSED TIME DUCT TO BUILDING
- = EXISTING BUILDING DUCT ROUTE
- = EXISTING BUILDING CABLE TRAY
- = PROPOSED TRUNKING
- = PROPOSED CONDUIT
- = CLAIM AREA
- 1W / 2W = 1 WAY OR 2 WAY DUCT
- GI = GALVANISED IRON DUCT
- PVC = PVC DUCT
- = HIDDEN DRAIN
- = VISIBLE DRAIN
- = TREES AND PLANTS

REV. NO.	REV. DATE	REV. BY	DESCRIPTION:

  
 TT dotCom Sdn Bhd (52371-A)  
 No 14, Jalan Majistret U1/26,  
 Hicom Glenmarie Industrial Park  
 40150 Shah Alam, Selangor Darul Ehsan, Malaysia.  
 Tel: +60 3 5032 6000  
 Website: www.time.com.my

PROJECT TITLE: FTK NEW 1W UNDERGROUND CIVIL & 1X144F CABLE PULLING INFRASTRUCTURE FROM BIDOR – H.MELINTANG (PACKAGE 4)	DRAWING TITLE: PROPOSED DRAWING (PREVENTIVE MAINTENANCE WITH ANTI RODENT 144C FIBER)
DRAWING NO: TTdC/0000/UMOB/LEML/0001	SHEET NO: 31 OF 21

DRAWING SCALE:	DRAWING UNITS:
N.T.S	METER
PREPARED BY:	INITIAL & DATE:
AMTEL RESOURCES SDN BHD	-
DESIGNED BY:	INITIAL & DATE:
JEMI	-
CHECKED BY:	INITIAL & DATE:
FAZWAN	-
APPROVED BY:	INITIAL & DATE:
-	-















KELULUSAN PLAN


Local Authorities:-

CONFIDENTIALITY

These drawings and details are and shall remain the property of TT dotCom Sdn Bhd. Both are issued in strict confidence and shall not be reproduced, copied or used in any manner without specific written permission from the owner.

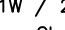LEGEND :- OUTSIDE PLANT

-  = BUILDING MANHOLE
-  = BUILDING PIT
-  = PROPOSED TIME MANHOLE
-  = EXISTING TIME MANHOLE
-  = PROPOSED TIME DUCT ROUTE
-  = PROPOSED TIME DUCT TO BUILDING
-  = EXISTING BUILDING DUCT ROUTE
-  = EXISTING BUILDING CABLE TRAY
-  = PROPOSED TRUNKING
-  = PROPOSED CONDUIT
-  = CLAIM AREA
- 1W / 2W = 1 WAY OR 2 WAY DUCT
- GI = GALVANISED IRON DUCT
- PVC = PVC DUCT
-  = HIDDEN DRAIN
-  = VISIBLE DRAIN
-  = TREES AND PLANTS

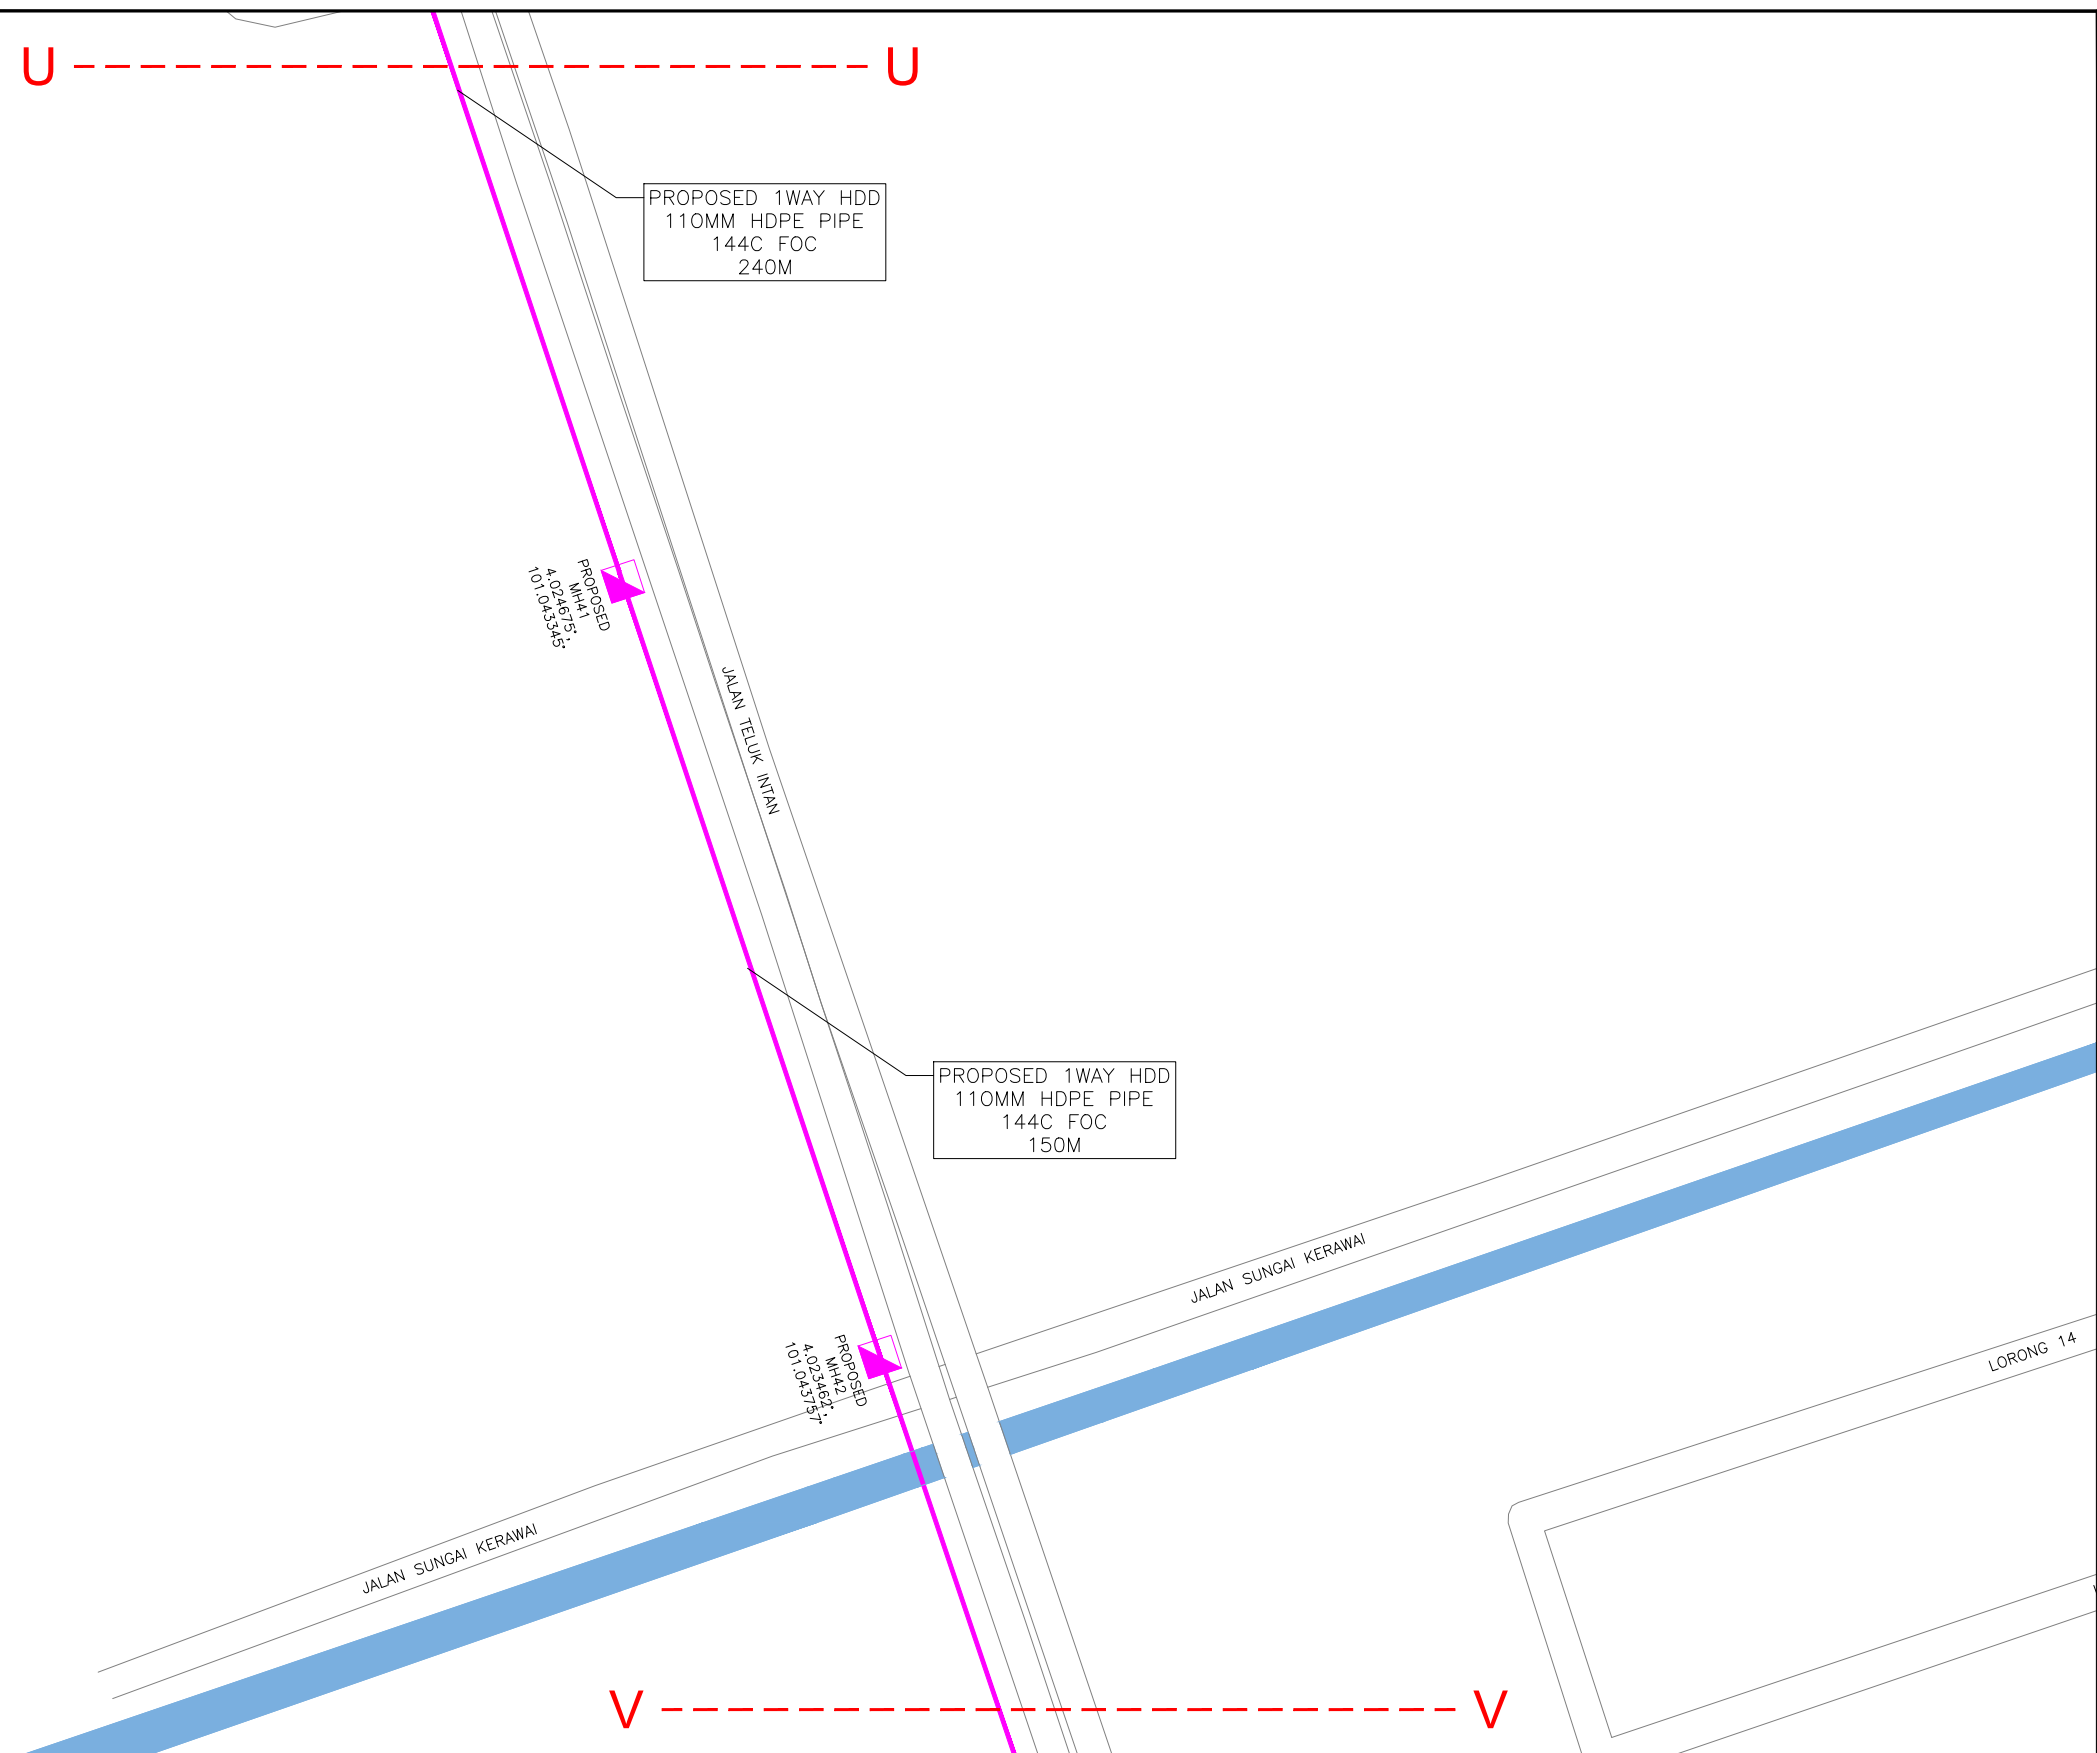


REV. NO.	REV. DATE	REV. BY	DESCRIPTION:



TT dotCom Sdn Bhd (52371-A)  
 No 14, Jalan Majistret U1/26,  
 Hicom Glenmarie Industrial Park  
 40150 Shah Alam, Selangor Darul Ehsan, Malaysia.  
 Tel: +60 3 5032 6000  
 Website: www.time.com.my

PROJECT TITLE: FTK NEW 1W UNDERGROUND CIVIL & 1X144F CABLE PULLING INFRASTRUCTURE FROM BIDOR – H.MELINTANG (PACKAGE 4)	
DRAWING TITLE: PROPOSED DRAWING (PREVENTIVE MAINTENANCE WITH ANTI RODENT 144C FIBER)	
DRAWING NO: TTdC/0000/UMOB/LEML/0001	SHEET NO: 31 OF 22

DRAWING SCALE: N.T.S	DRAWING UNITS: METER
PREPARED BY: AMTEL RESOURCES SDN BHD	INITIAL & DATE: -
DESIGNED BY: JEMI	INITIAL & DATE: -
CHECKED BY: FAZWAN	INITIAL & DATE: -
APPROVED BY: -	INITIAL & DATE: -

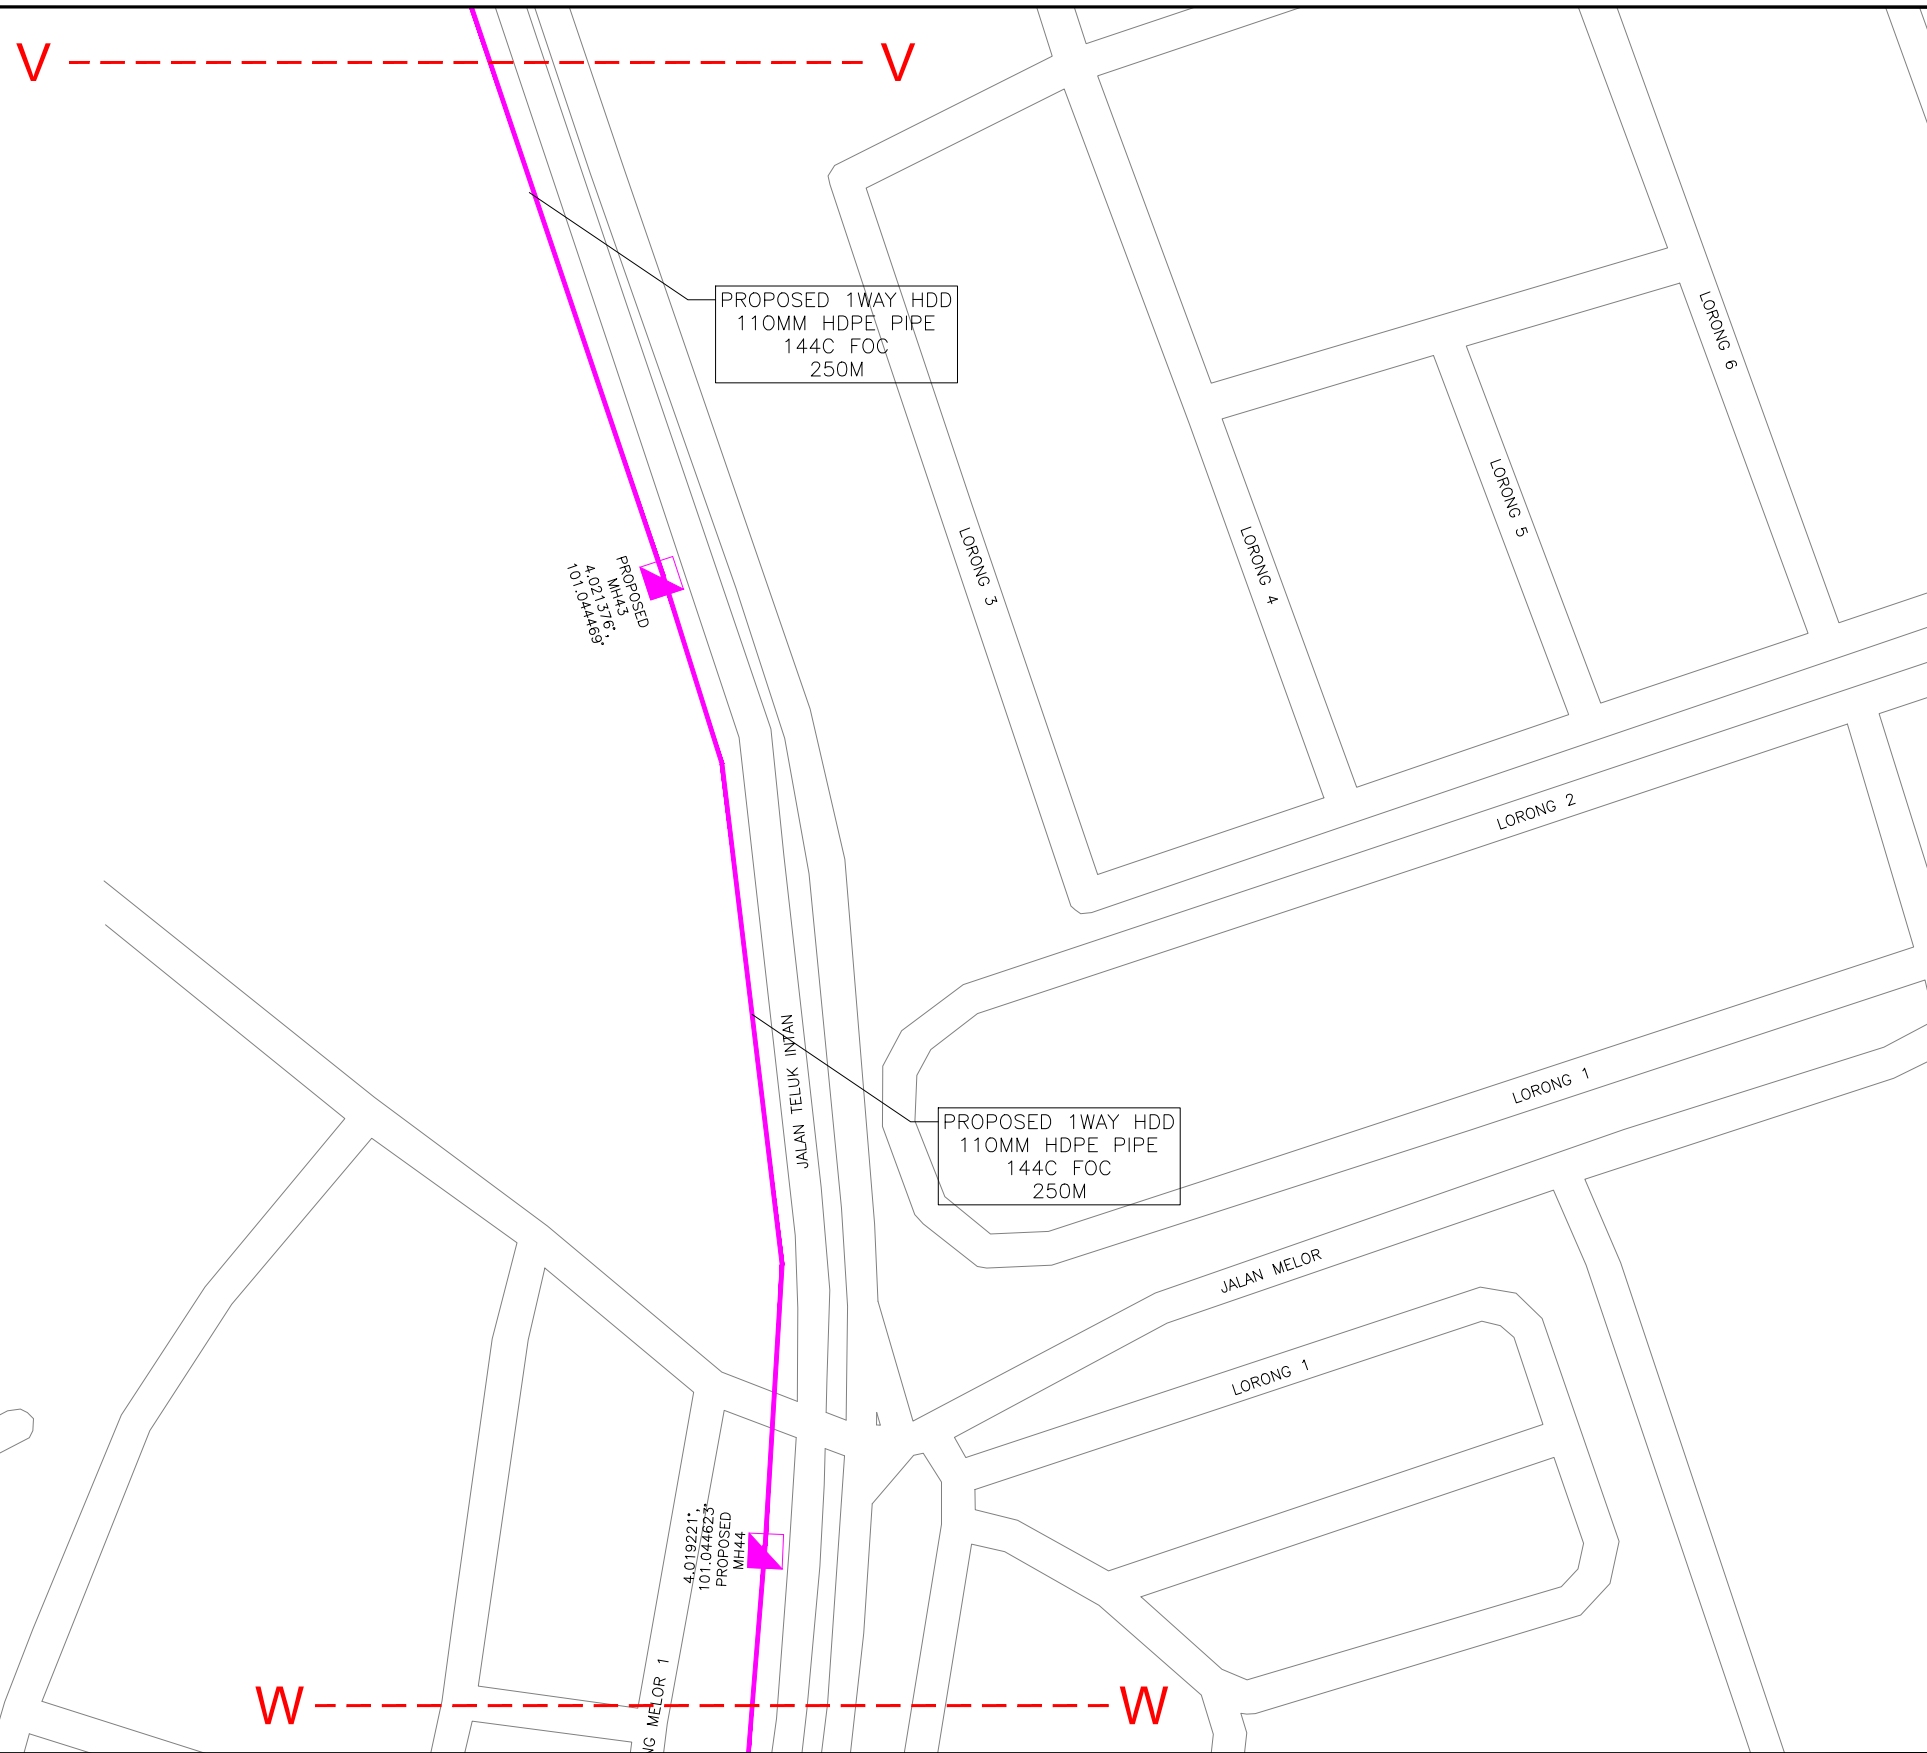

KELULUSAN PLAN

Local Authorities:-

CONFIDENTIALITY

These drawings and details are and shall remain the property of TT dotCom Sdn Bhd. Both are issued in strict confidence and shall not be reproduced, copied or used in any manner without specific written permission from the owner.

LEGEND :- OUTSIDE PLANT

- = BUILDING MANHOLE
- = BUILDING PIT
- = PROPOSED TIME MANHOLE
- = EXISTING TIME MANHOLE
- = PROPOSED TIME DUCT ROUTE
- = PROPOSED TIME DUCT TO BUILDING
- = EXISTING BUILDING DUCT ROUTE
- = EXISTING BUILDING CABLE TRAY
- = PROPOSED TRUNKING
- = PROPOSED CONDUIT
- = CLAIM AREA
- 1W / 2W = 1 WAY OR 2 WAY DUCT
- GI = GALVANISED IRON DUCT
- PVC = PVC DUCT
- = HIDDEN DRAIN
- = VISIBLE DRAIN
- = TREES AND PLANTS


REV. NO.	REV. DATE	REV. BY	DESCRIPTION:



TT dotCom Sdn Bhd (52371-A)  
 No 14, Jalan Majistret U1/26,  
 Hicom Glenmarie Industrial Park  
 40150 Shah Alam, Selangor Darul Ehsan, Malaysia.  
 Tel: +60 3 5032 6000  
 Website: www.time.com.my

PROJECT TITLE: FTK NEW 1W UNDERGROUND CIVIL & 1X144F CABLE PULLING INFRASTRUCTURE FROM BIDOR – H.MELINTANG (PACKAGE 4)	
DRAWING TITLE: PROPOSED DRAWING (PREVENTIVE MAINTENANCE WITH ANTI RODENT 144C FIBER)	
DRAWING NO: TTdC/0000/UMOB/LEML/0001	SHEET NO: 31 OF 23

DRAWING SCALE: N.T.S	DRAWING UNITS: METER
PREPARED BY: AMTEL RESOURCES SDN BHD	INITIAL & DATE: -
DESIGNED BY: JEMI	INITIAL & DATE: -
CHECKED BY: FAZWAN	INITIAL & DATE: -
APPROVED BY: -	INITIAL & DATE: -

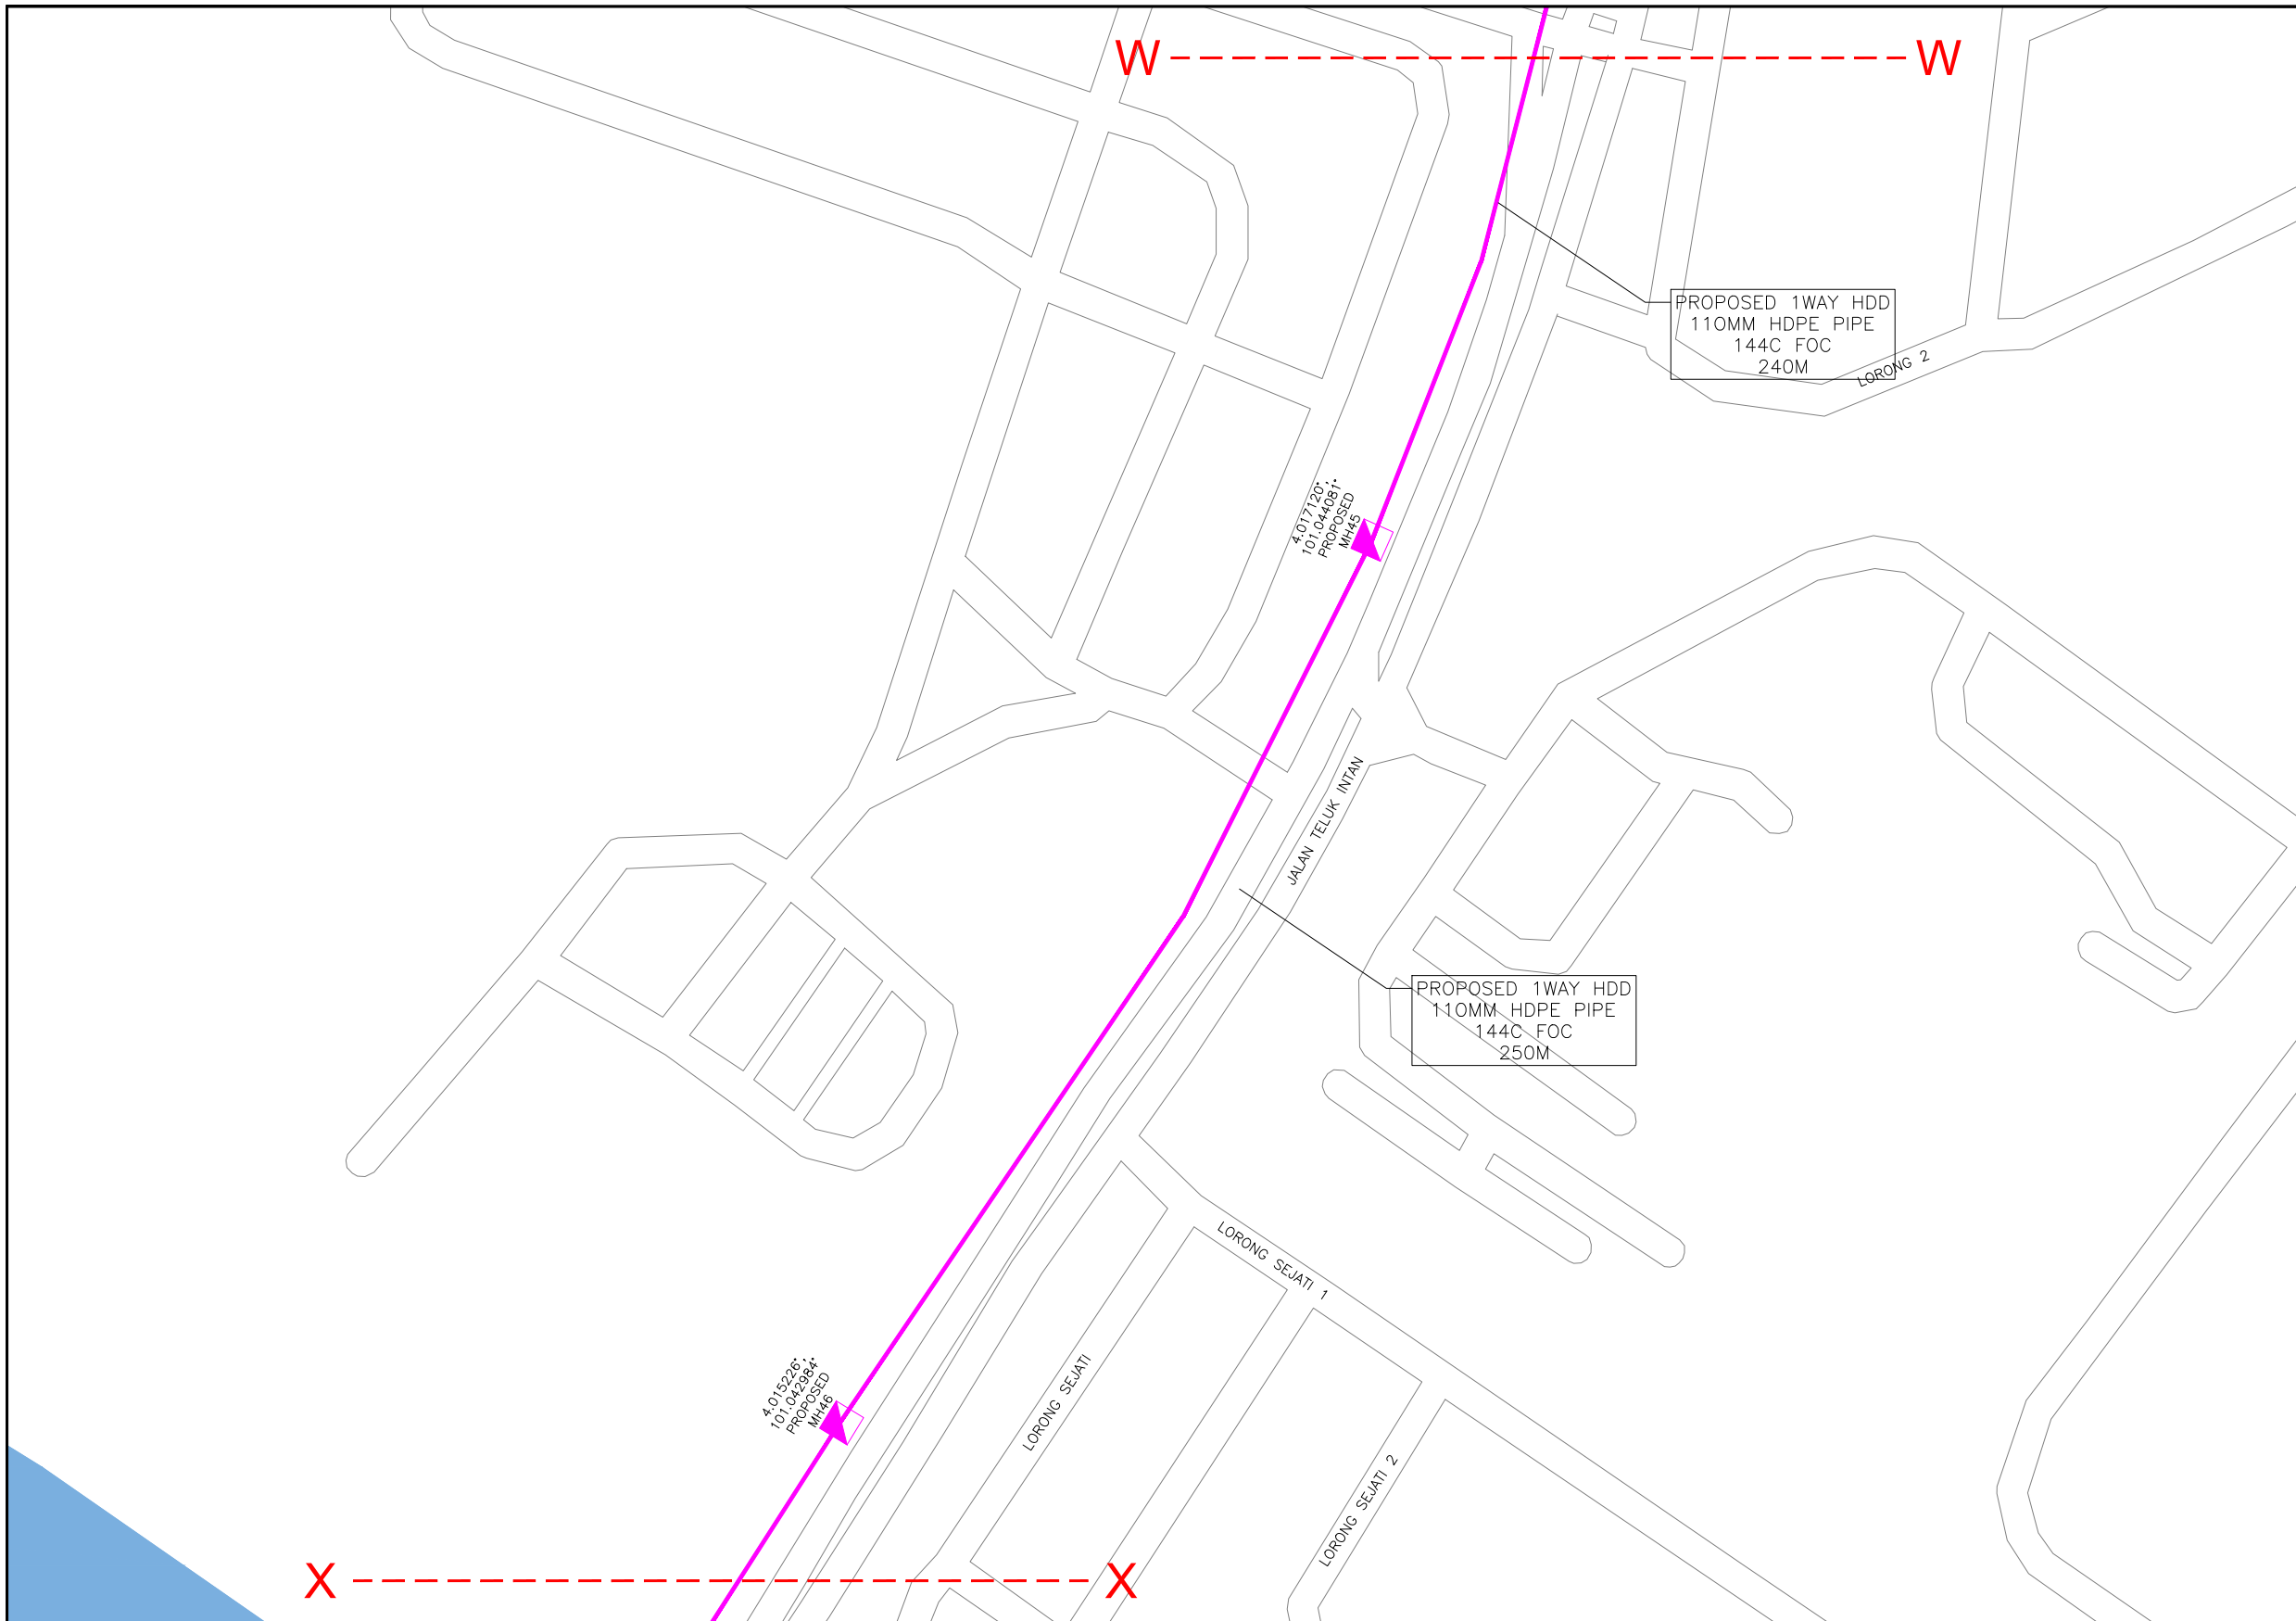

KELULUSAN PLAN

Local Authorities:-

CONFIDENTIALITY

These drawings and details are and shall remain the property of TT dotCom Sdn Bhd. Both are issued in strict confidence and shall not be reproduced, copied or used in any manner without specific written permission from the owner.

LEGEND :- OUTSIDE PLANT

- = BUILDING MANHOLE
- = BUILDING PIT
- = PROPOSED TIME MANHOLE
- = EXISTING TIME MANHOLE
- = PROPOSED TIME DUCT ROUTE
- = PROPOSED TIME DUCT TO BUILDING
- = EXISTING BUILDING DUCT ROUTE
- = EXISTING BUILDING CABLE TRAY
- = PROPOSED TRUNKING
- = PROPOSED CONDUIT
- = CLAIM AREA
- 1W / 2W = 1 WAY OR 2 WAY DUCT
- GI = GALVANISED IRON DUCT
- PVC = PVC DUCT
- = HIDDEN DRAIN
- = VISIBLE DRAIN
- = TREES AND PLANTS


REV. NO.	REV. DATE	REV. BY	DESCRIPTION:



TT dotCom Sdn Bhd (52371-A)  
 No 14, Jalan Majistret U1/26,  
 Hicom Glenmarie Industrial Park  
 40150 Shah Alam, Selangor Darul Ehsan, Malaysia.  
 Tel: +60 3 5032 6000  
 Website: www.time.com.my

PROJECT TITLE: FTK NEW 1W UNDERGROUND CIVIL & 1X144F CABLE PULLING INFRASTRUCTURE FROM BIDOR – H.MELINTANG (PACKAGE 4)	DRAWING TITLE: PROPOSED DRAWING (PREVENTIVE MAINTENANCE WITH ANTI RODENT 144C FIBER)
DRAWING NO: TTdC/0000/UMOB/LEML/0001	SHEET NO: 31 OF 24

DRAWING SCALE: N.T.S	DRAWING UNITS: METER
PREPARED BY: AMTEL RESOURCES SDN BHD	INITIAL & DATE: -
DESIGNED BY: JEMI	INITIAL & DATE: -
CHECKED BY: FAZWAN	INITIAL & DATE: -
APPROVED BY: -	INITIAL & DATE: -

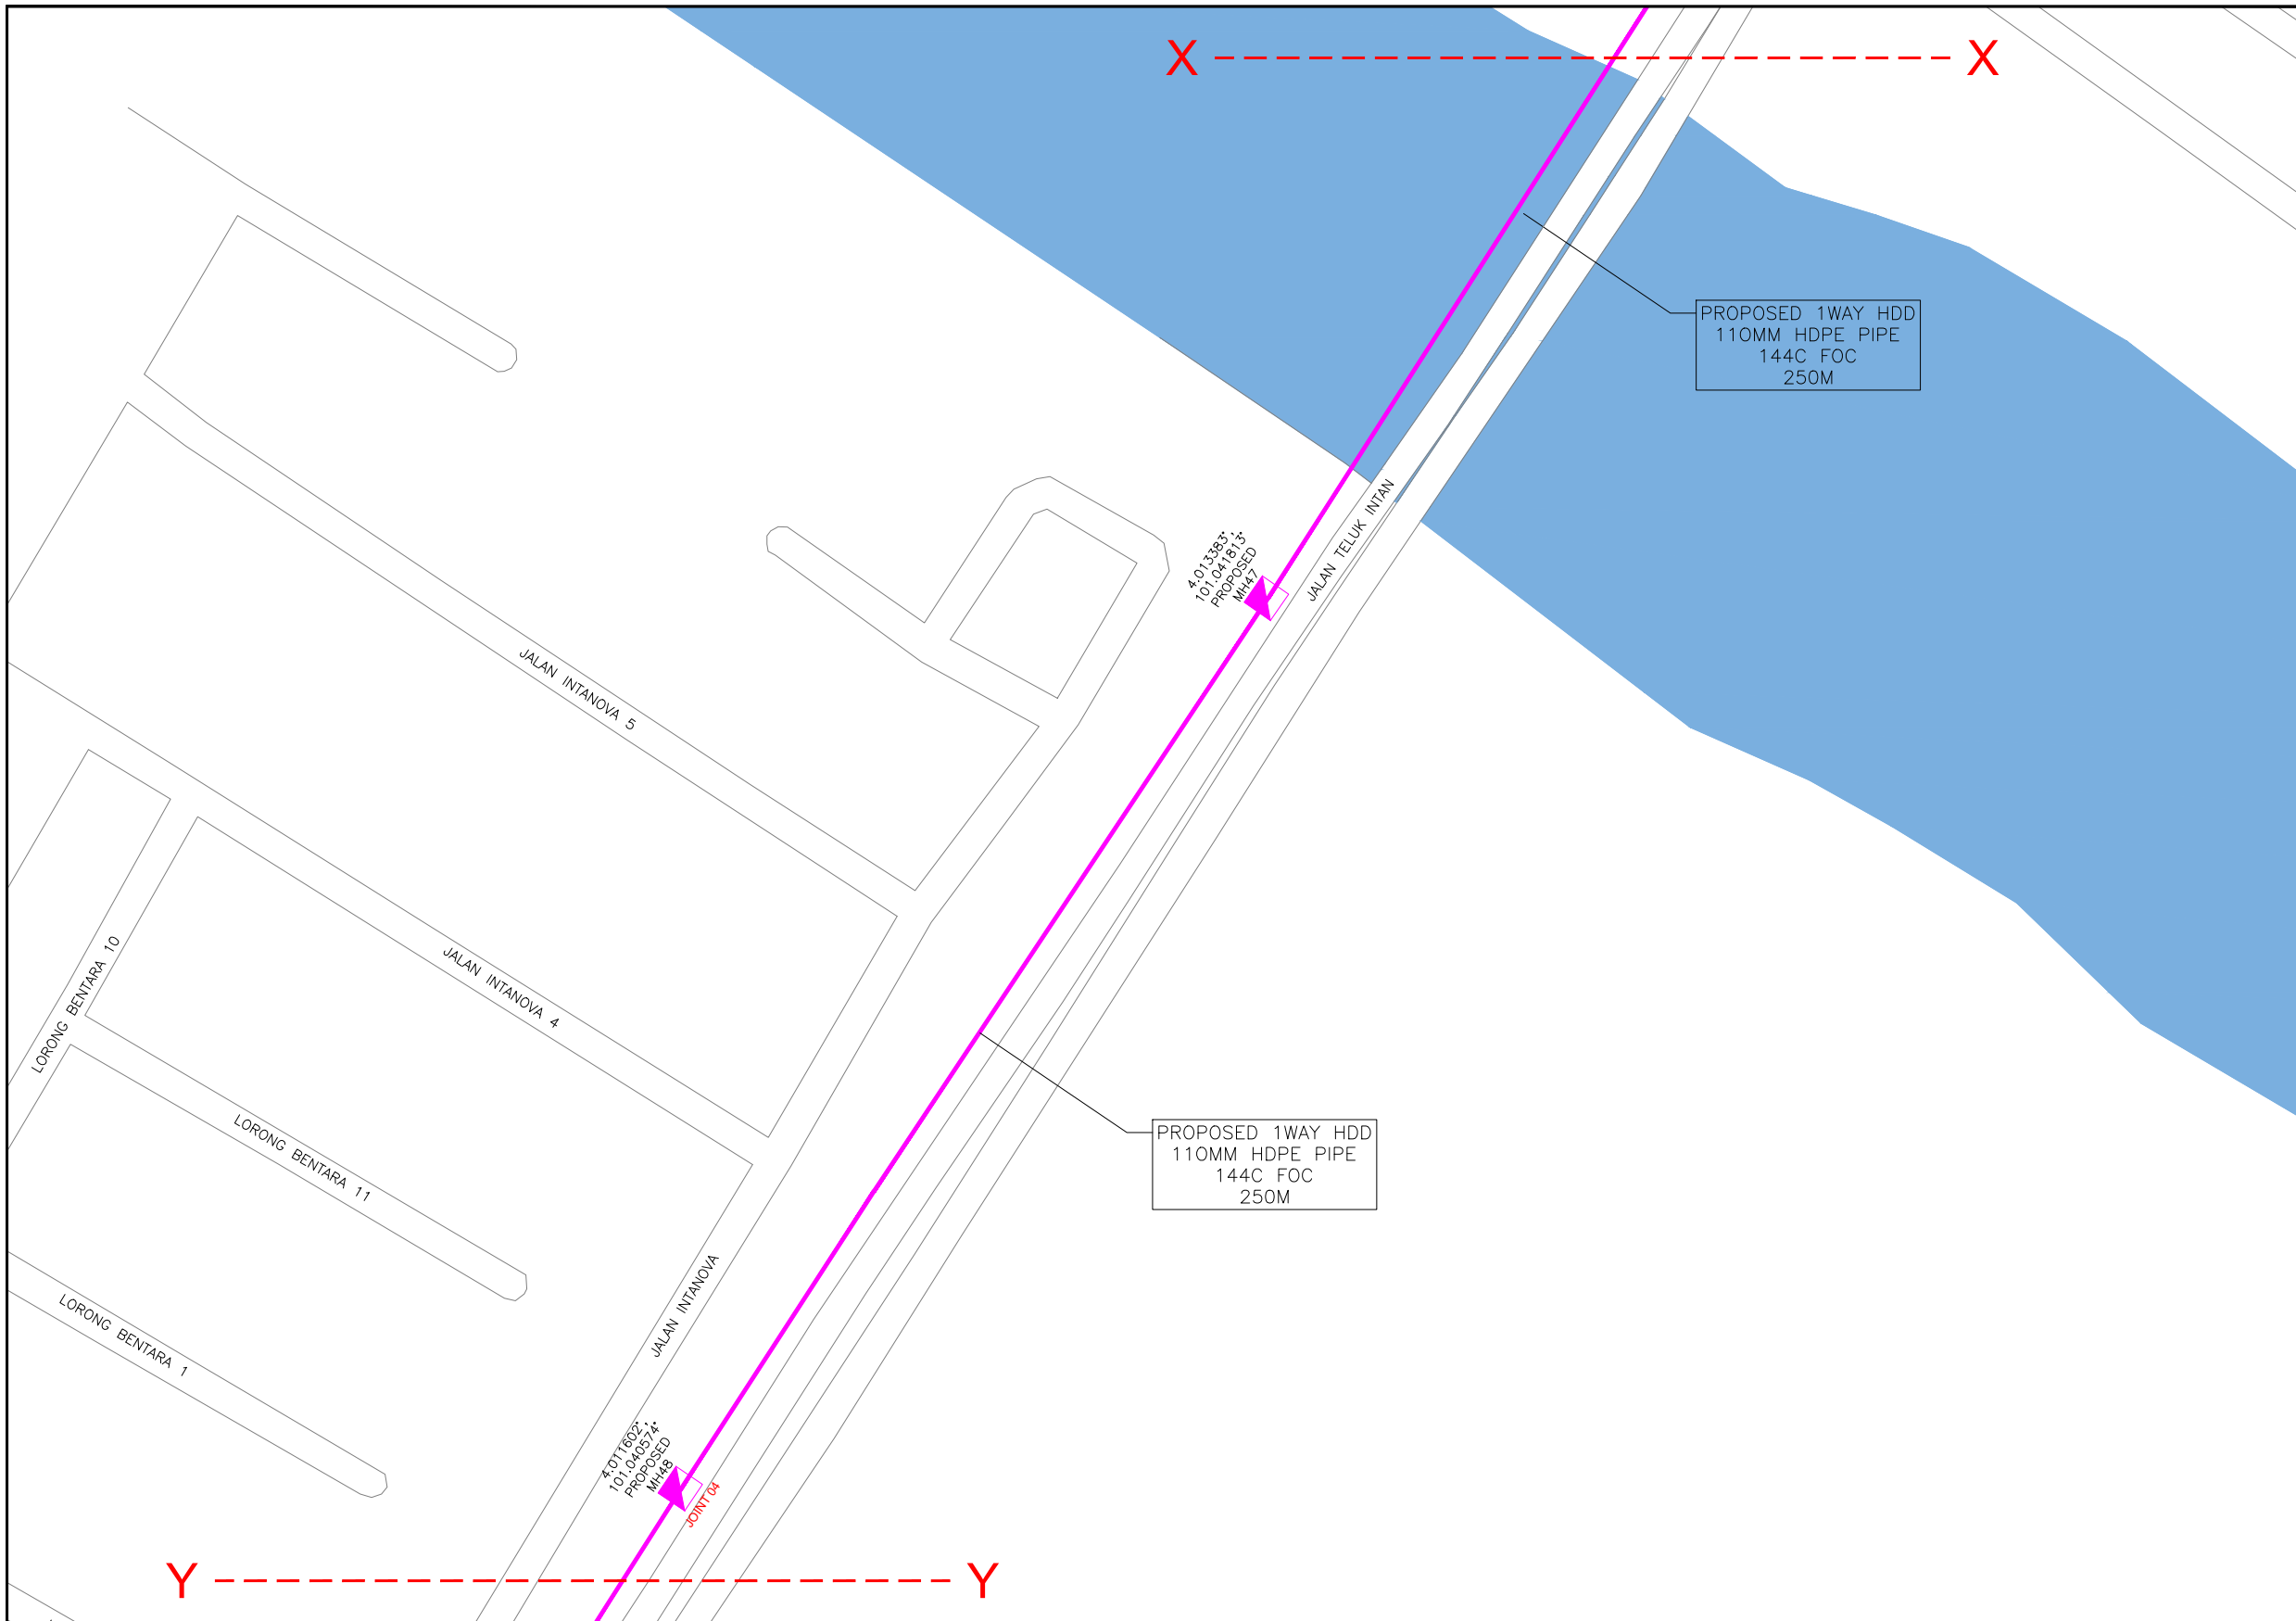

KELULUSAN PLAN

Local Authorities:-

CONFIDENTIALITY

These drawings and details are and shall remain the property of TT dotCom Sdn Bhd. Both are issued in strict confidence and shall not be reproduced, copied or used in any manner without specific written permission from the owner.

LEGEND :- OUTSIDE PLANT

- = BUILDING MANHOLE
- = BUILDING PIT
- = PROPOSED TIME MANHOLE
- = EXISTING TIME MANHOLE
- = PROPOSED TIME DUCT ROUTE
- = PROPOSED TIME DUCT TO BUILDING
- = EXISTING BUILDING DUCT ROUTE
- = EXISTING BUILDING CABLE TRAY
- = PROPOSED TRUNKING
- = PROPOSED CONDUIT
- = CLAIM AREA
- 1W / 2W = 1 WAY OR 2 WAY DUCT
- GI = GALVANISED IRON DUCT
- PVC = PVC DUCT
- = HIDDEN DRAIN
- = VISIBLE DRAIN
- = TREES AND PLANTS


REV. NO.	REV. DATE	REV. BY	DESCRIPTION:



TT dotCom Sdn Bhd (52371-A)  
 No 14, Jalan Majistret U1/26,  
 Hicom Glenmarie Industrial Park  
 40150 Shah Alam, Selangor Darul Ehsan, Malaysia.  
 Tel: +60 3 5032 6000  
 Website: www.time.com.my

PROJECT TITLE: FTK NEW 1W UNDERGROUND CIVIL & 1X144F CABLE PULLING INFRASTRUCTURE FROM BIDOR – H.MELINTANG (PACKAGE 4)	
DRAWING TITLE: PROPOSED DRAWING (PREVENTIVE MAINTENANCE WITH ANTI RODENT 144C FIBER)	
DRAWING NO: TTdC/0000/UMOB/LEML/0001	SHEET NO: 31 OF 25

DRAWING SCALE: N.T.S	DRAWING UNITS: METER
PREPARED BY: AMTEL RESOURCES SDN BHD	INITIAL & DATE: -
DESIGNED BY: JEMI	INITIAL & DATE: -
CHECKED BY: FAZWAN	INITIAL & DATE: -
APPROVED BY: -	INITIAL & DATE: -

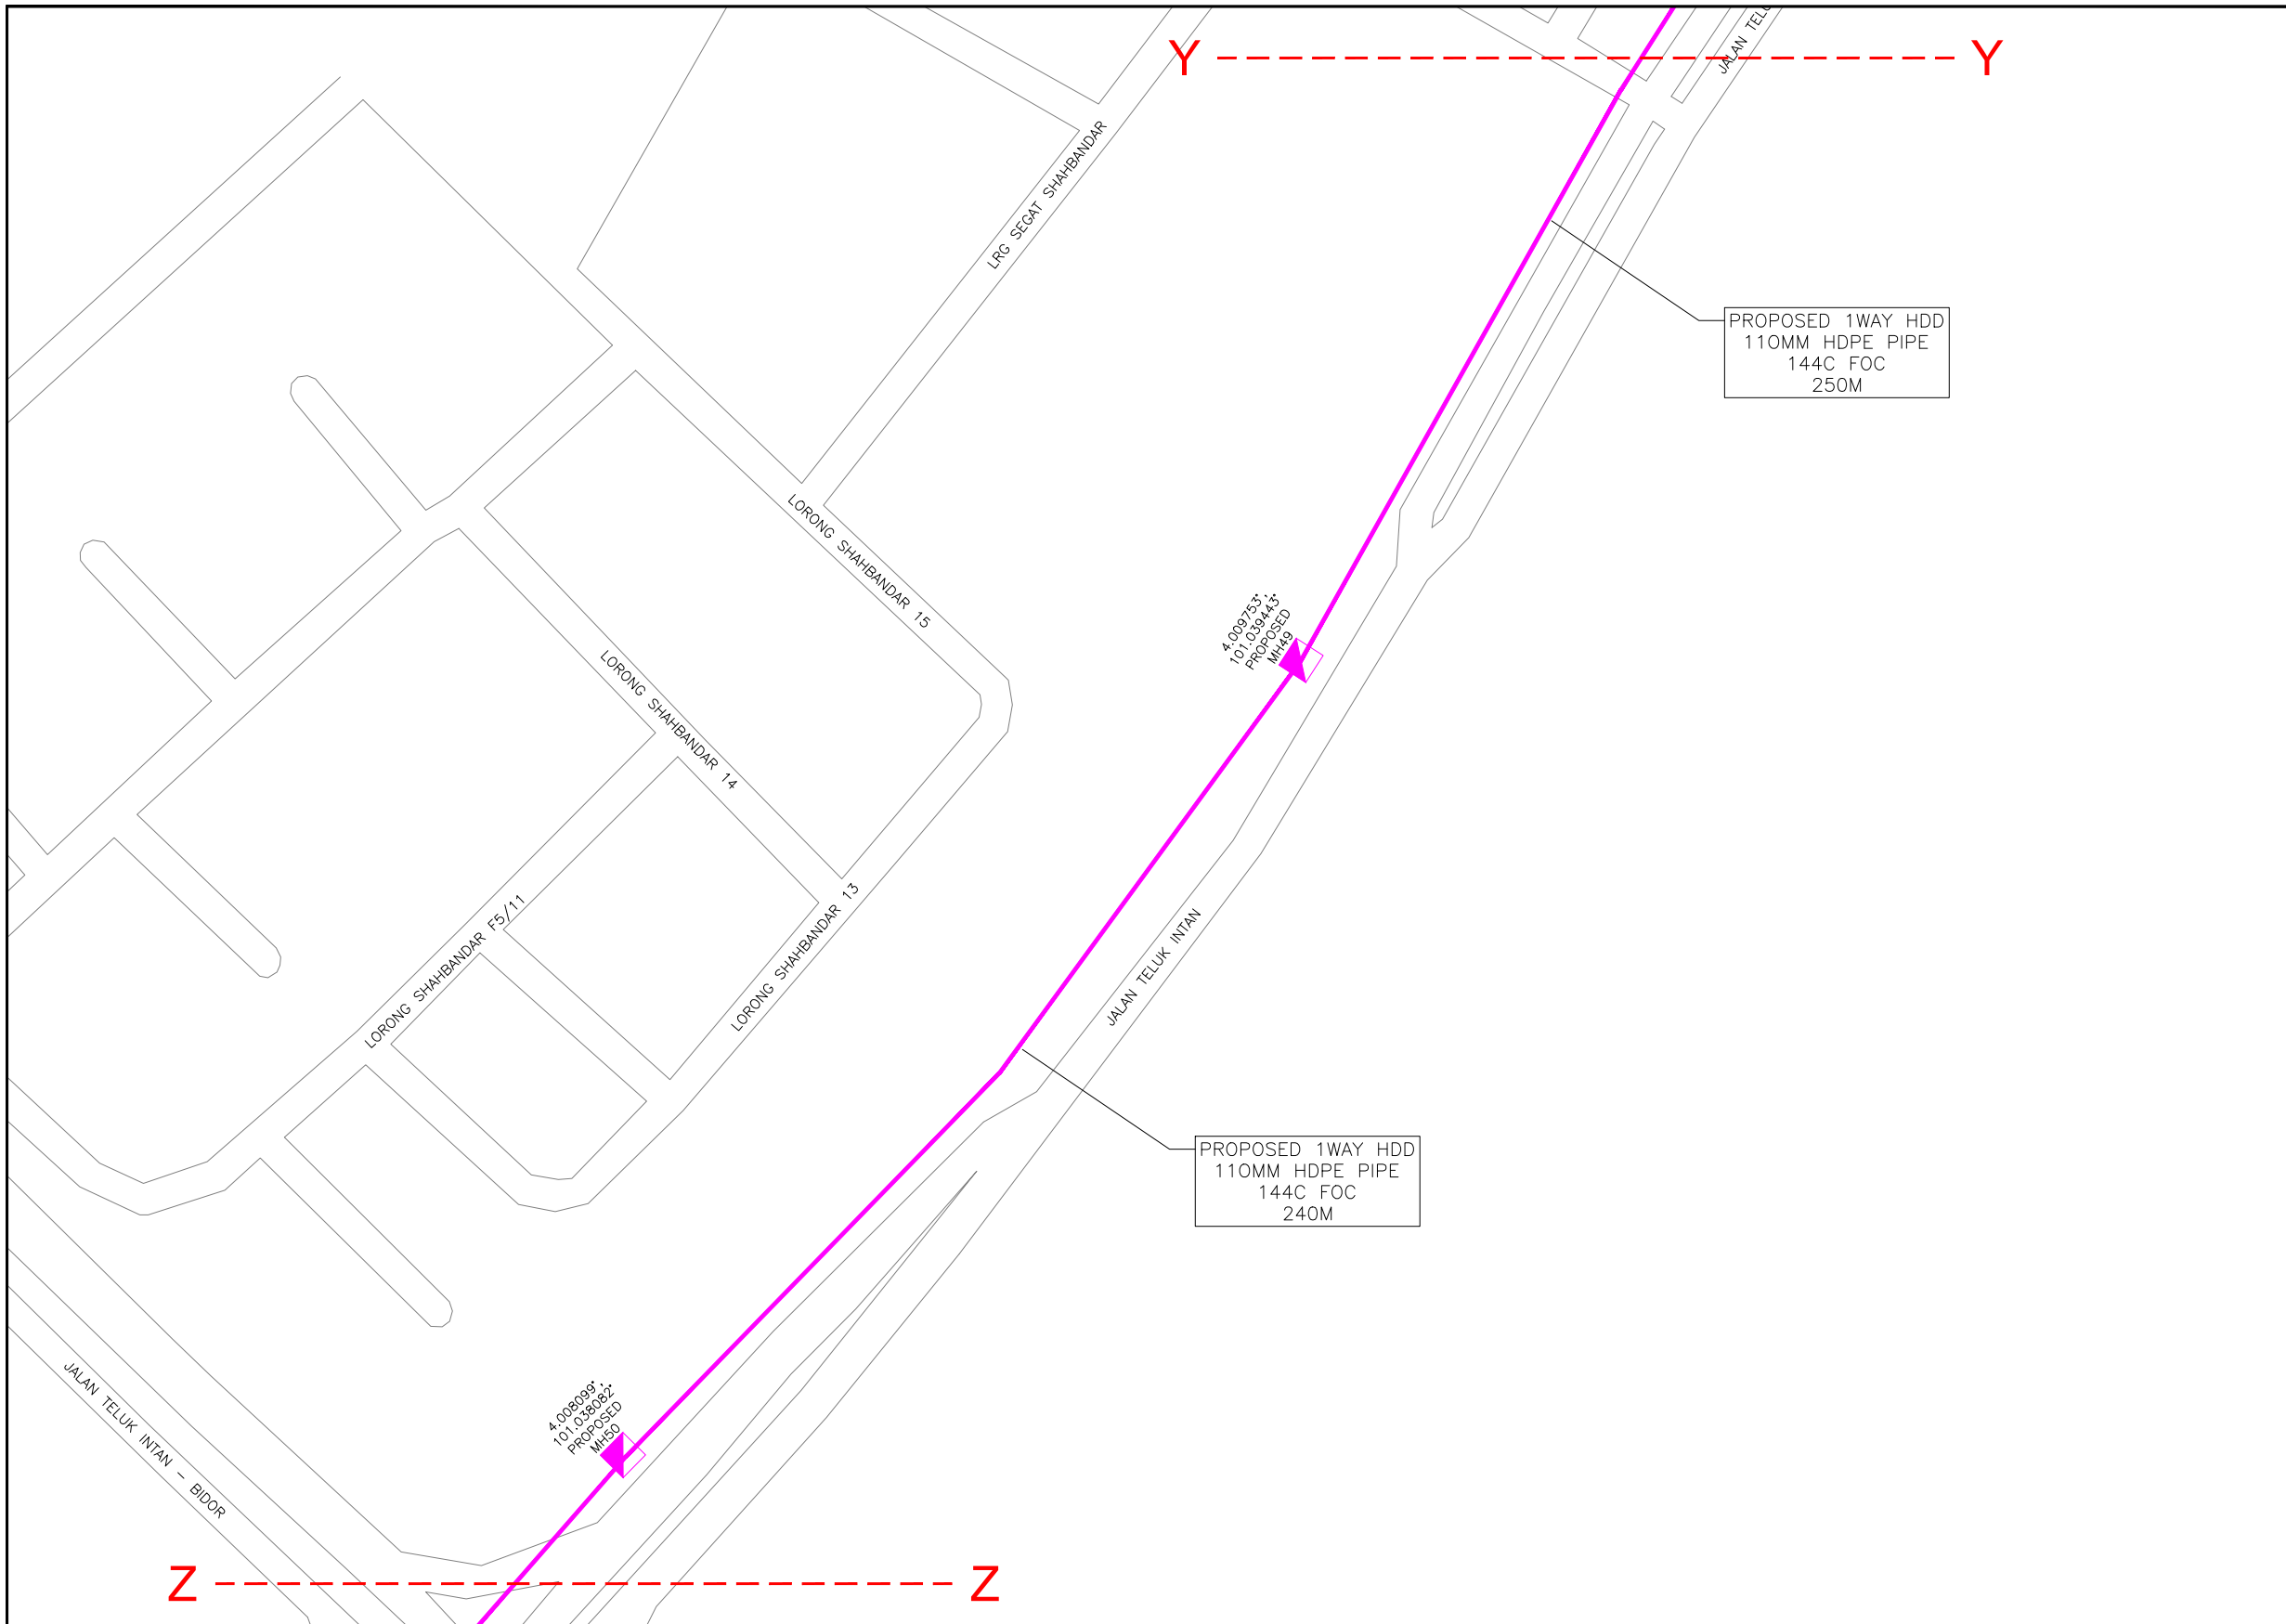

KELULUSAN PLAN

Local Authorities:-

CONFIDENTIALITY

These drawings and details are and shall remain the property of TT dotCom Sdn Bhd. Both are issued in strict confidence and shall not be reproduced, copied or used in any manner without specific written permission from the owner.

LEGEND :- OUTSIDE PLANT

- = BUILDING MANHOLE
- = BUILDING PIT
- = PROPOSED TIME MANHOLE
- = EXISTING TIME MANHOLE
- = PROPOSED TIME DUCT ROUTE
- = PROPOSED TIME DUCT TO BUILDING
- = EXISTING BUILDING DUCT ROUTE
- = EXISTING BUILDING CABLE TRAY
- = PROPOSED TRUNKING
- = PROPOSED CONDUIT
- = CLAIM AREA
- 1W / 2W = 1 WAY OR 2 WAY DUCT
- GI = GALVANISED IRON DUCT
- PVC = PVC DUCT
- = HIDDEN DRAIN
- = VISIBLE DRAIN
- = TREES AND PLANTS

REV. NO.	REV. DATE	REV. BY	DESCRIPTION:




TT dotCom Sdn Bhd (52371-A)  
 No 14, Jalan Majistret U1/26,  
 Hicom Glenmarie Industrial Park  
 40150 Shah Alam, Selangor Darul Ehsan, Malaysia.  
 Tel: +60 3 5032 6000  
 Website: www.time.com.my

PROJECT TITLE:  
 FTK NEW 1W UNDERGROUND CIVIL & 1X144F CABLE  
 PULLING INFRASTRUCTURE FROM  
 BIDOR – H.MELINTANG (PACKAGE 4)

DRAWING TITLE:  
 PROPOSED DRAWING  
 (PREVENTIVE MAINTENANCE WITH ANTI RODENT  
 144C FIBER)

DRAWING NO: TTdC/0000/UMOB/LEML/0001      SHEET NO: 31 OF 26

DRAWING SCALE: N.T.S	DRAWING UNITS: METER
PREPARED BY: AMTEL RESOURCES SDN BHD	INITIAL & DATE: -
DESIGNED BY: JEMI	INITIAL & DATE: -
CHECKED BY: FAZWAN	INITIAL & DATE: -
APPROVED BY: -	INITIAL & DATE: -

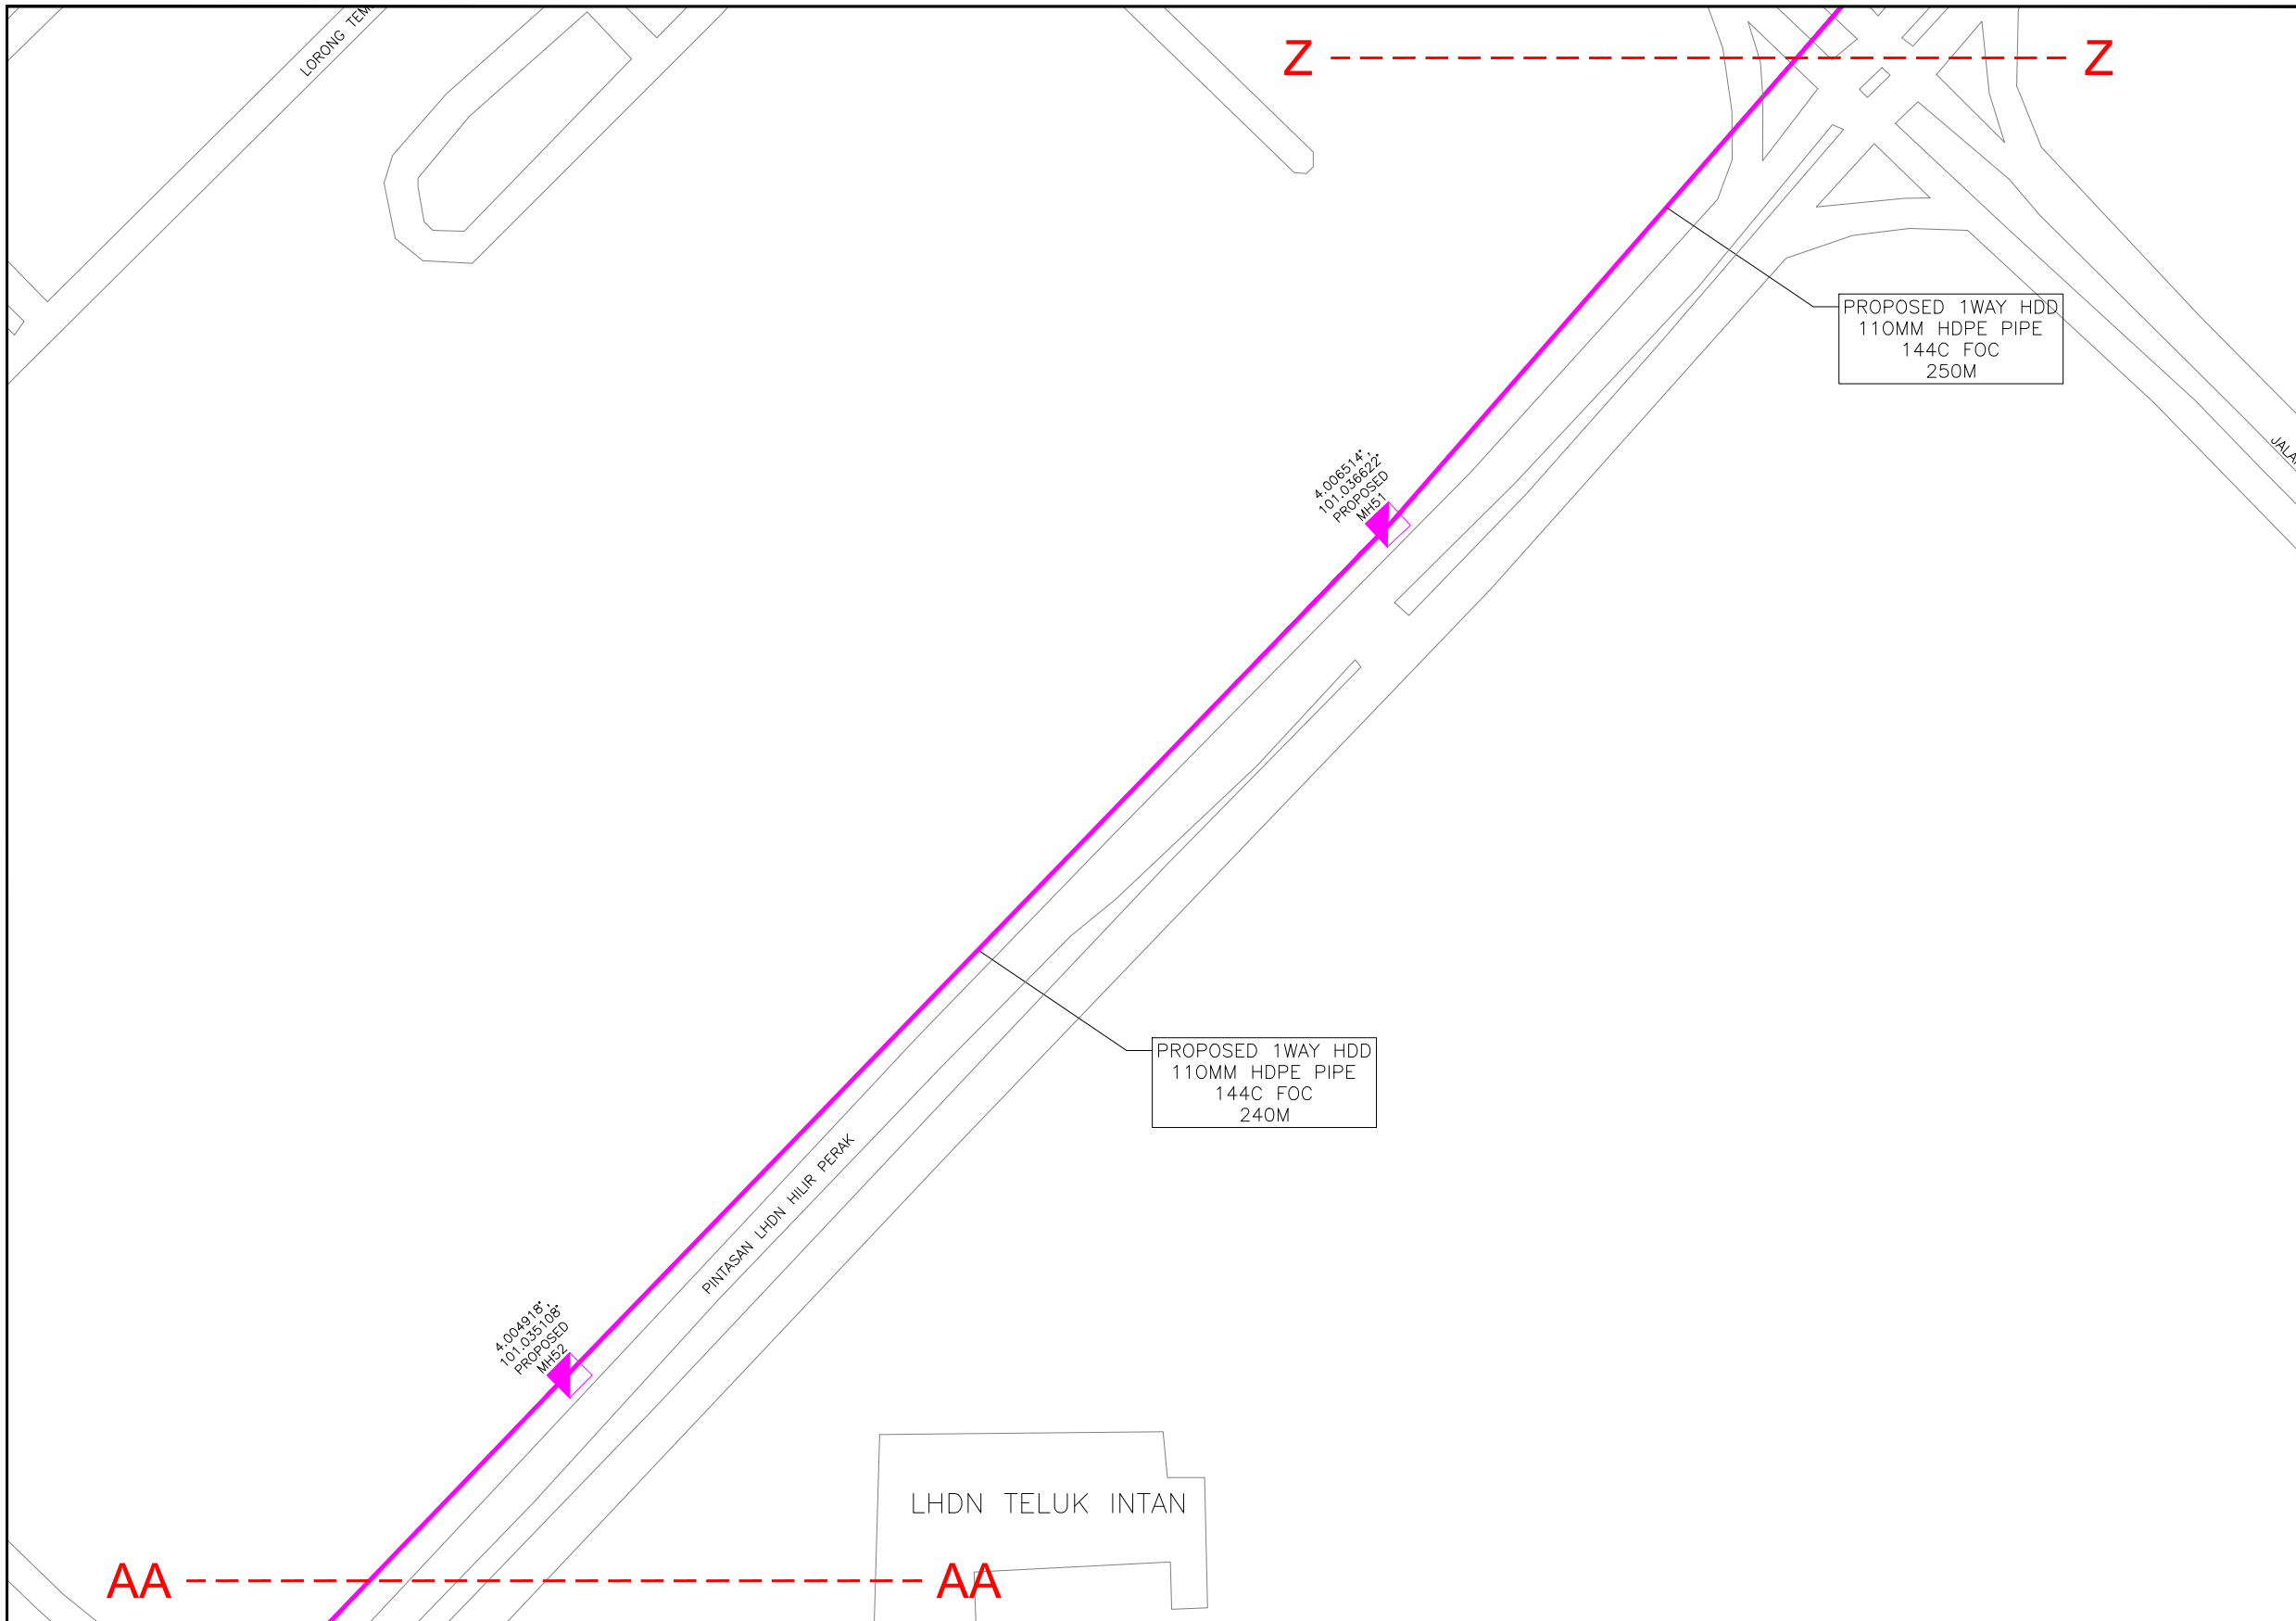

KELULUSAN PLAN

Local Authorities:-

CONFIDENTIALITY

These drawings and details are and shall remain the property of TT dotCom Sdn Bhd. Both are issued in strict confidence and shall not be reproduced, copied or used in any manner without specific written permission from the owner.

LEGEND :- OUTSIDE PLANT

- = BUILDING MANHOLE
- = BUILDING PIT
- = PROPOSED TIME MANHOLE
- = EXISTING TIME MANHOLE
- = PROPOSED TIME DUCT ROUTE
- = PROPOSED TIME DUCT TO BUILDING
- = EXISTING BUILDING DUCT ROUTE
- = EXISTING BUILDING CABLE TRAY
- = PROPOSED TRUNKING
- = PROPOSED CONDUIT
- = CLAIM AREA
- 1W / 2W = 1 WAY OR 2 WAY DUCT
- GI = GALVANISED IRON DUCT
- PVC = PVC DUCT
- = HIDDEN DRAIN
- = VISIBLE DRAIN
- = TREES AND PLANTS


REV. NO.	REV. DATE	REV. BY	DESCRIPTION:



TT dotCom Sdn Bhd (52371-A)  
 No 14, Jalan Majistret U1/26,  
 Hicom Glenmarie Industrial Park  
 40150 Shah Alam, Selangor Darul Ehsan, Malaysia.  
 Tel: +60 3 5032 6000  
 Website: www.time.com.my

PROJECT TITLE: FTK NEW 1W UNDERGROUND CIVIL & 1X144F CABLE PULLING INFRASTRUCTURE FROM BIDOR – H.MELINTANG (PACKAGE 4)	
DRAWING TITLE: PROPOSED DRAWING (PREVENTIVE MAINTENANCE WITH ANTI RODENT 144C FIBER)	
DRAWING NO: TTdC/0000/UMOB/LEML/0001	SHEET NO: 31 OF 27

DRAWING SCALE: N.T.S	DRAWING UNITS: METER
PREPARED BY: AMTEL RESOURCES SDN BHD	INITIAL & DATE: -
DESIGNED BY: JEMI	INITIAL & DATE: -
CHECKED BY: FAZWAN	INITIAL & DATE: -
APPROVED BY: -	INITIAL & DATE: -

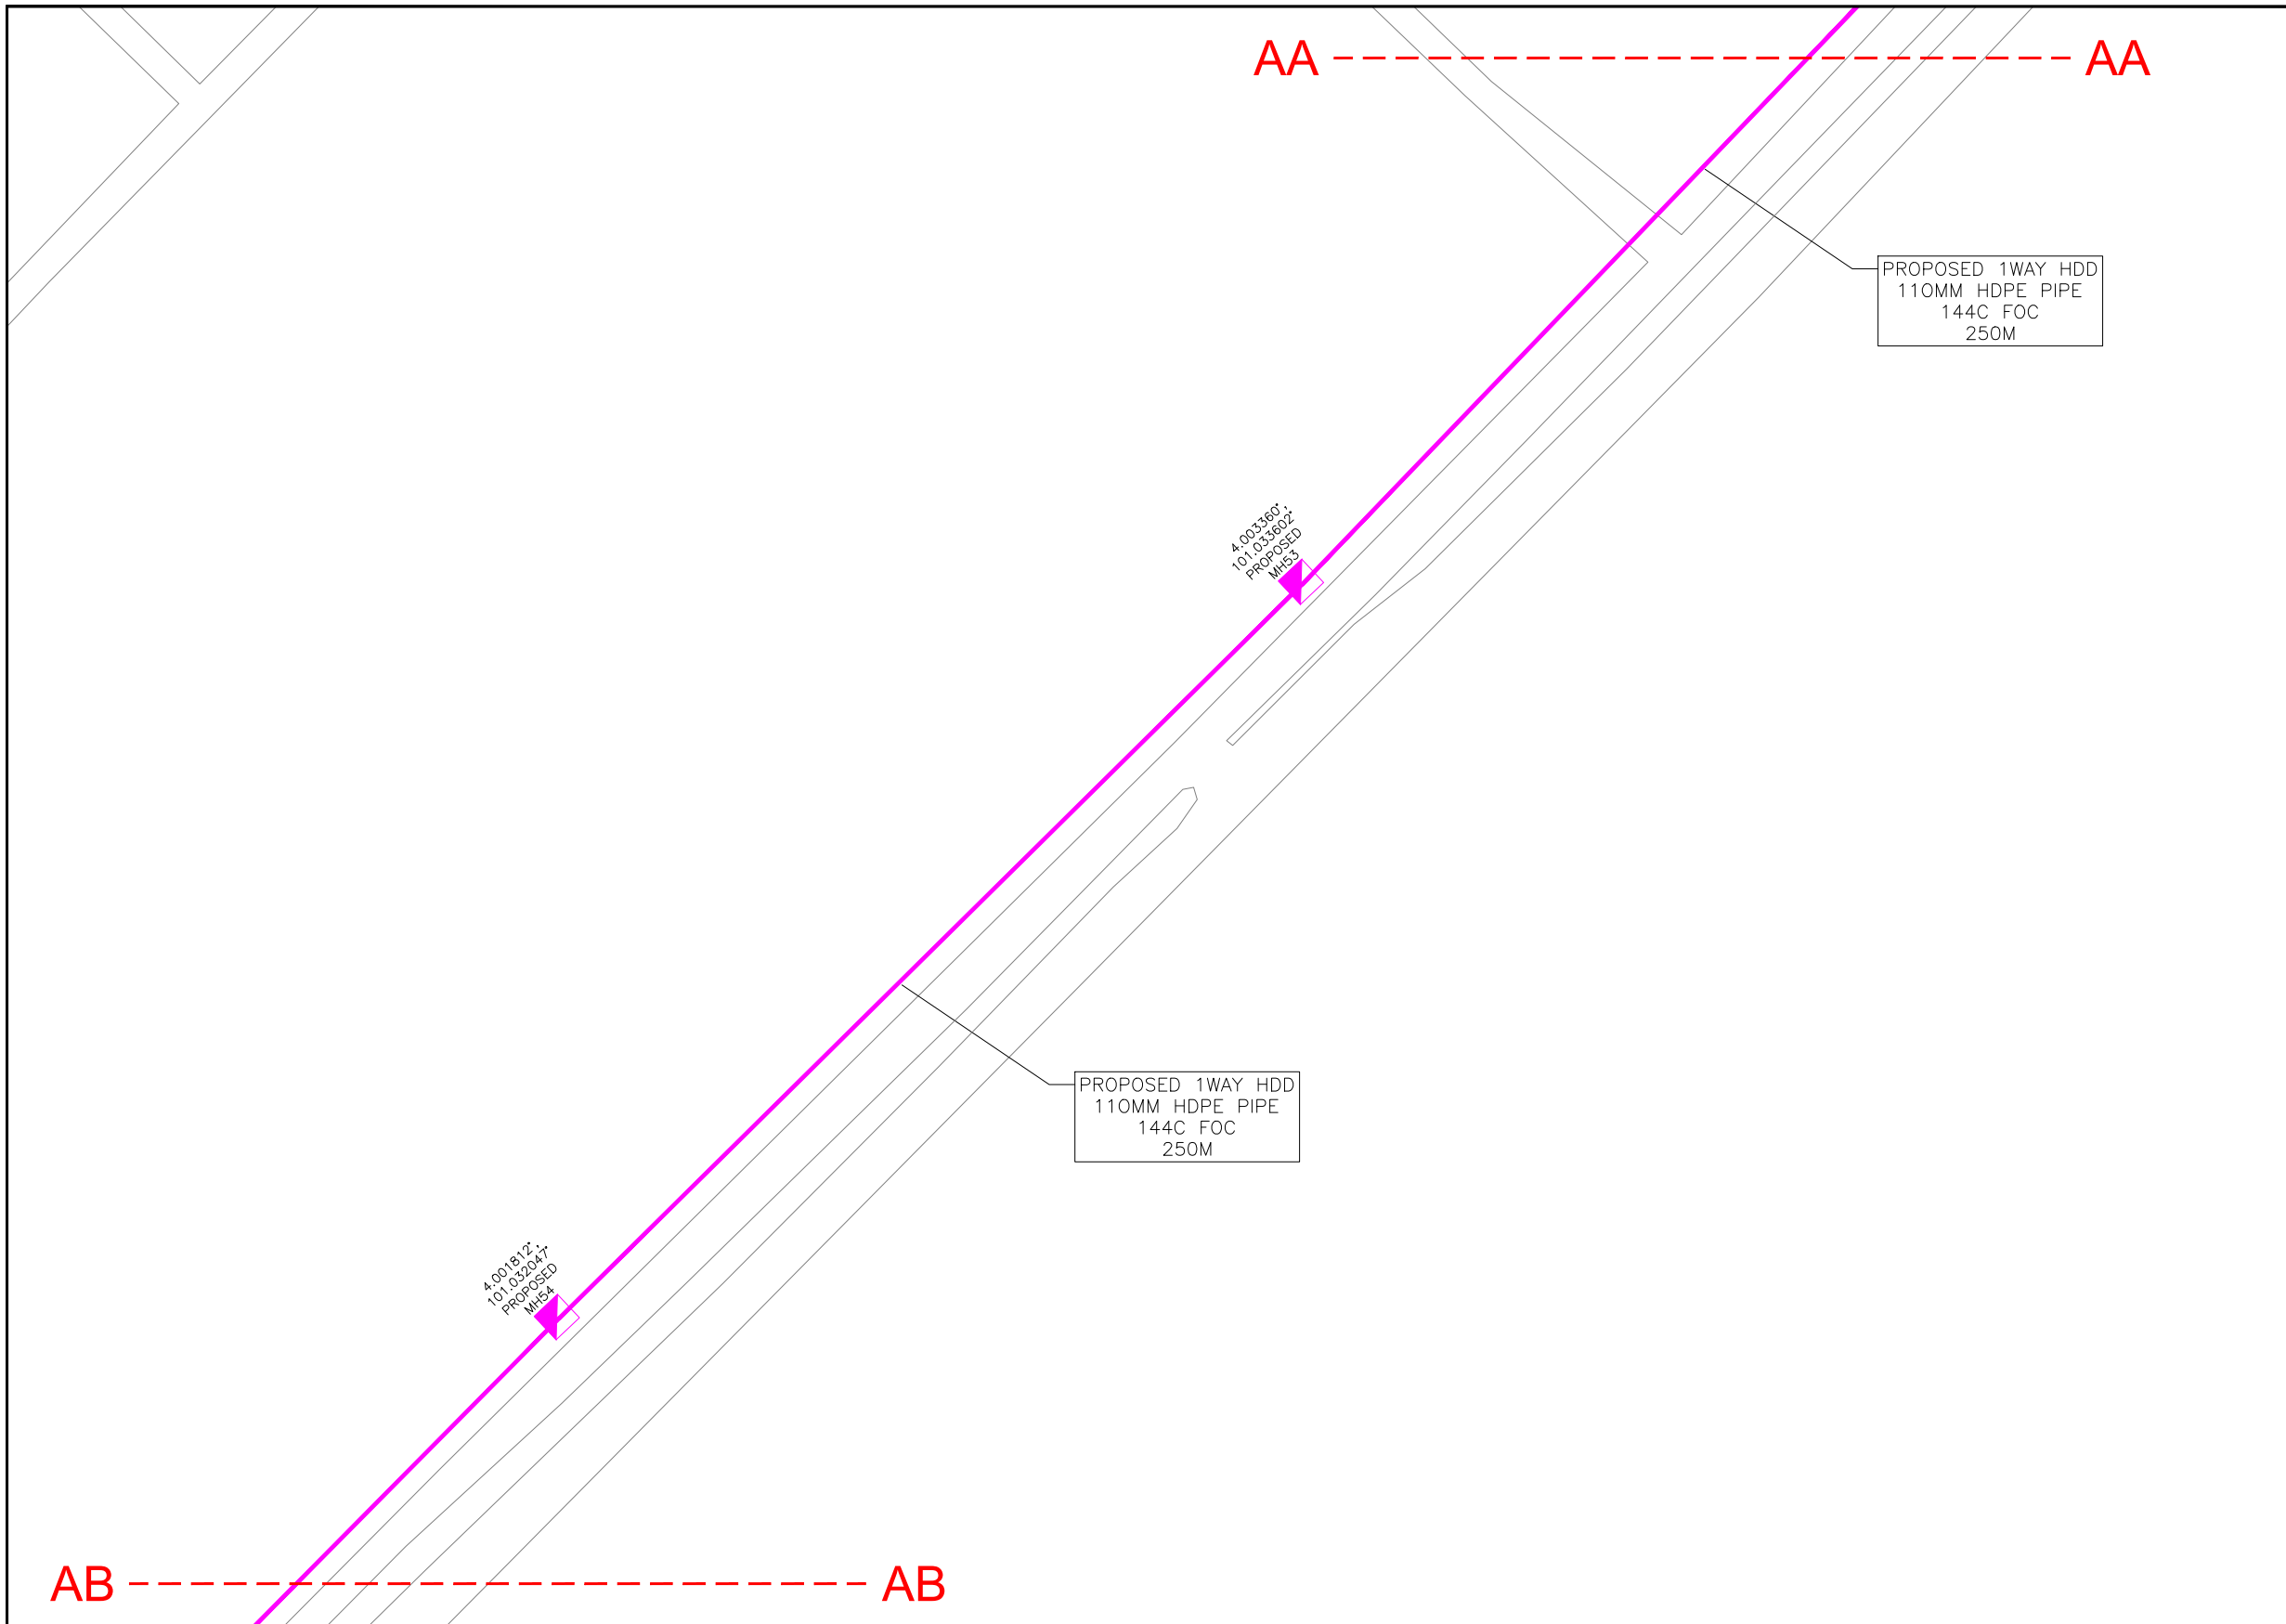

KELULUSAN PLAN

Local Authorities:-

CONFIDENTIALITY

These drawings and details are and shall remain the property of TT dotCom Sdn Bhd. Both are issued in strict confidence and shall not be reproduced, copied or used in any manner without specific written permission from the owner.

LEGEND :- OUTSIDE PLANT

- = BUILDING MANHOLE
- = BUILDING PIT
- = PROPOSED TIME MANHOLE
- = EXISTING TIME MANHOLE
- = PROPOSED TIME DUCT ROUTE
- = PROPOSED TIME DUCT TO BUILDING
- = EXISTING BUILDING DUCT ROUTE
- = EXISTING BUILDING CABLE TRAY
- = PROPOSED TRUNKING
- = PROPOSED CONDUIT
- = CLAIM AREA
- 1W / 2W = 1 WAY OR 2 WAY DUCT
- GI = GALVANISED IRON DUCT
- PVC = PVC DUCT
- = HIDDEN DRAIN
- = VISIBLE DRAIN
- = TREES AND PLANTS


REV. NO.	REV. DATE	REV. BY	DESCRIPTION:



TT dotCom Sdn Bhd (52371-A)  
 No 14, Jalan Majistret U1/26,  
 Hicom Glenmarie Industrial Park  
 40150 Shah Alam, Selangor Darul Ehsan, Malaysia.  
 Tel: +60 3 5032 6000  
 Website: www.time.com.my

PROJECT TITLE: FTK NEW 1W UNDERGROUND CIVIL & 1X144F CABLE PULLING INFRASTRUCTURE FROM BIDOR – H.MELINTANG (PACKAGE 4)	
DRAWING TITLE: PROPOSED DRAWING (PREVENTIVE MAINTENANCE WITH ANTI RODENT 144C FIBER)	
DRAWING NO: TTdC/0000/UMOB/LEML/0001	SHEET NO: 31 OF 28

DRAWING SCALE: N.T.S	DRAWING UNITS: METER
PREPARED BY: AMTEL RESOURCES SDN BHD	INITIAL & DATE: -
DESIGNED BY: JEMI	INITIAL & DATE: -
CHECKED BY: FAZWAN	INITIAL & DATE: -
APPROVED BY: -	INITIAL & DATE: -

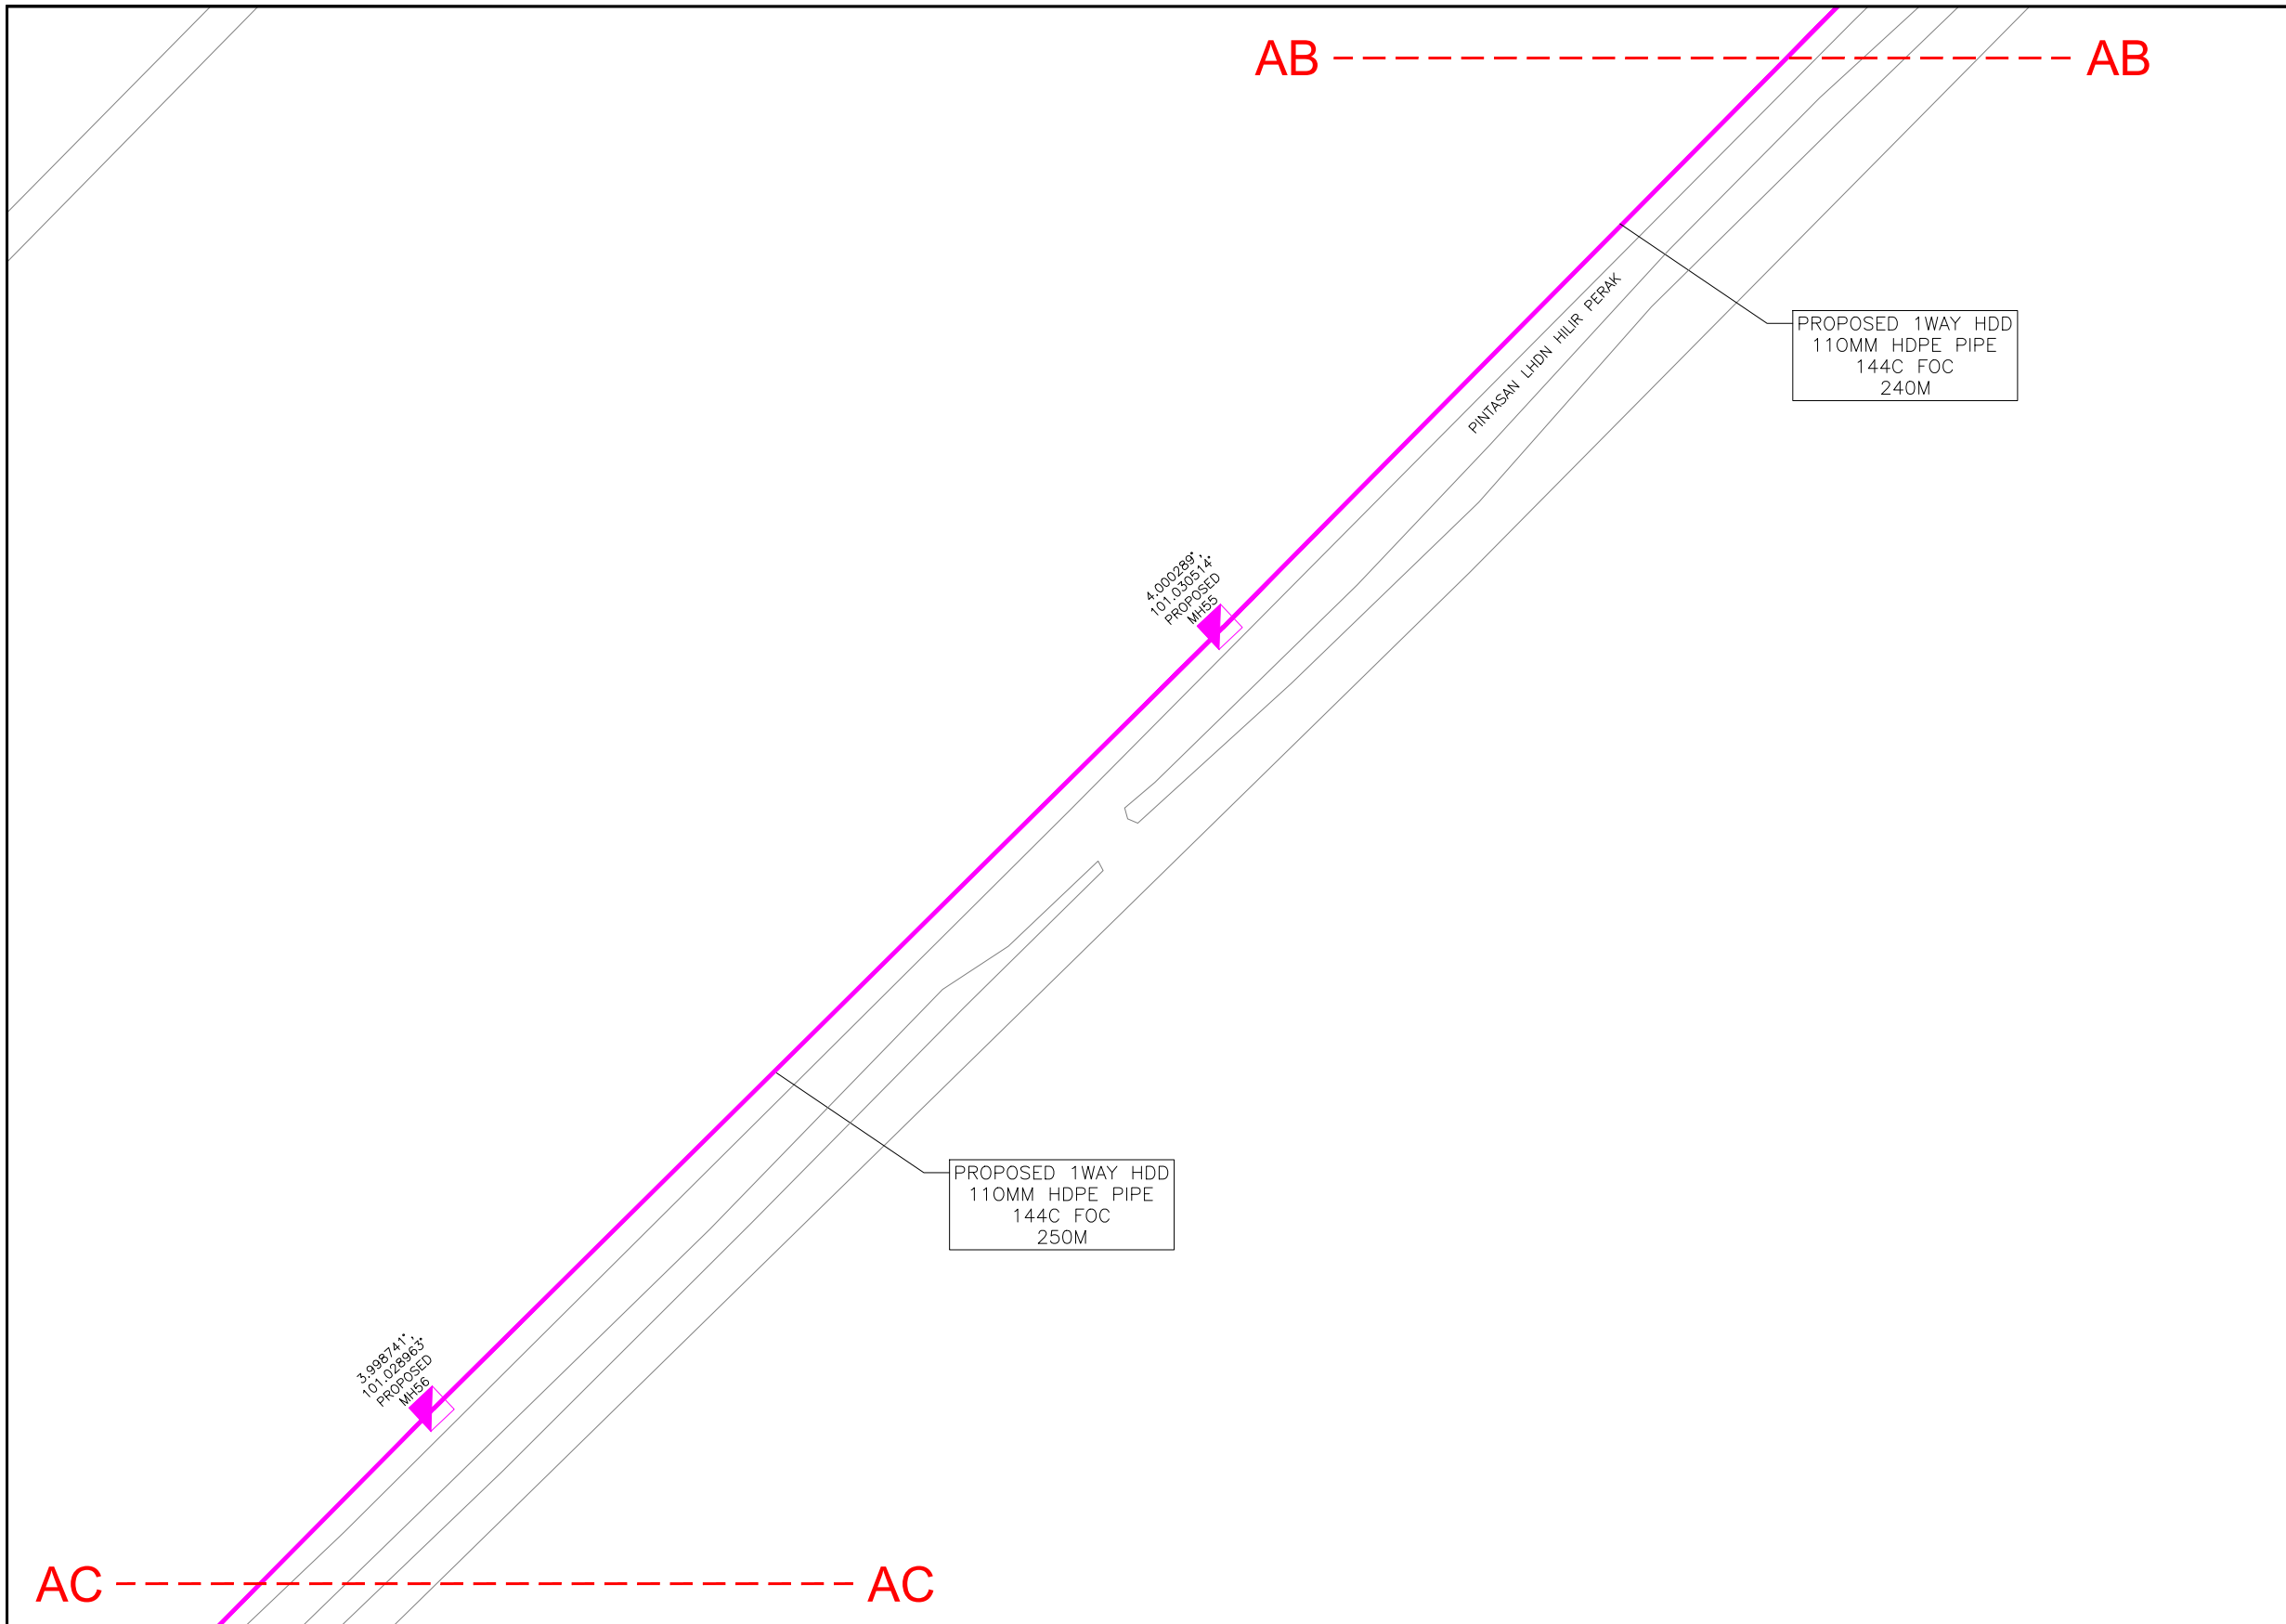

KELULUSAN PLAN

Local Authorities:-

CONFIDENTIALITY

These drawings and details are and shall remain the property of TT dotCom Sdn Bhd. Both are issued in strict confidence and shall not be reproduced, copied or used in any manner without specific written permission from the owner.

LEGEND :- OUTSIDE PLANT

- = BUILDING MANHOLE
- = BUILDING PIT
- = PROPOSED TIME MANHOLE
- = EXISTING TIME MANHOLE
- = PROPOSED TIME DUCT ROUTE
- = PROPOSED TIME DUCT TO BUILDING
- = EXISTING BUILDING DUCT ROUTE
- = EXISTING BUILDING CABLE TRAY
- = PROPOSED TRUNKING
- = PROPOSED CONDUIT
- = CLAIM AREA
- 1W / 2W = 1 WAY OR 2 WAY DUCT
- GI = GALVANISED IRON DUCT
- PVC = PVC DUCT
- = HIDDEN DRAIN
- = VISIBLE DRAIN
- = TREES AND PLANTS


REV. NO.	REV. DATE	REV. BY	DESCRIPTION:



TT dotCom Sdn Bhd (52371-A)  
 No 14, Jalan Majistret U1/26,  
 Hicom Glenmarie Industrial Park  
 40150 Shah Alam, Selangor Darul Ehsan, Malaysia.  
 Tel: +60 3 5032 6000  
 Website: www.time.com.my

PROJECT TITLE: FTK NEW 1W UNDERGROUND CIVIL & 1X144F CABLE PULLING INFRASTRUCTURE FROM BIDOR – H.MELINTANG (PACKAGE 4)	
DRAWING TITLE: PROPOSED DRAWING (PREVENTIVE MAINTENANCE WITH ANTI RODENT 144C FIBER)	
DRAWING NO: TTdC/0000/UMOB/LEML/0001	SHEET NO: 31 OF 29

DRAWING SCALE: N.T.S	DRAWING UNITS: METER
PREPARED BY: AMTEL RESOURCES SDN BHD	INITIAL & DATE: -
DESIGNED BY: JEMI	INITIAL & DATE: -
CHECKED BY: FAZWAN	INITIAL & DATE: -
APPROVED BY: -	INITIAL & DATE: -

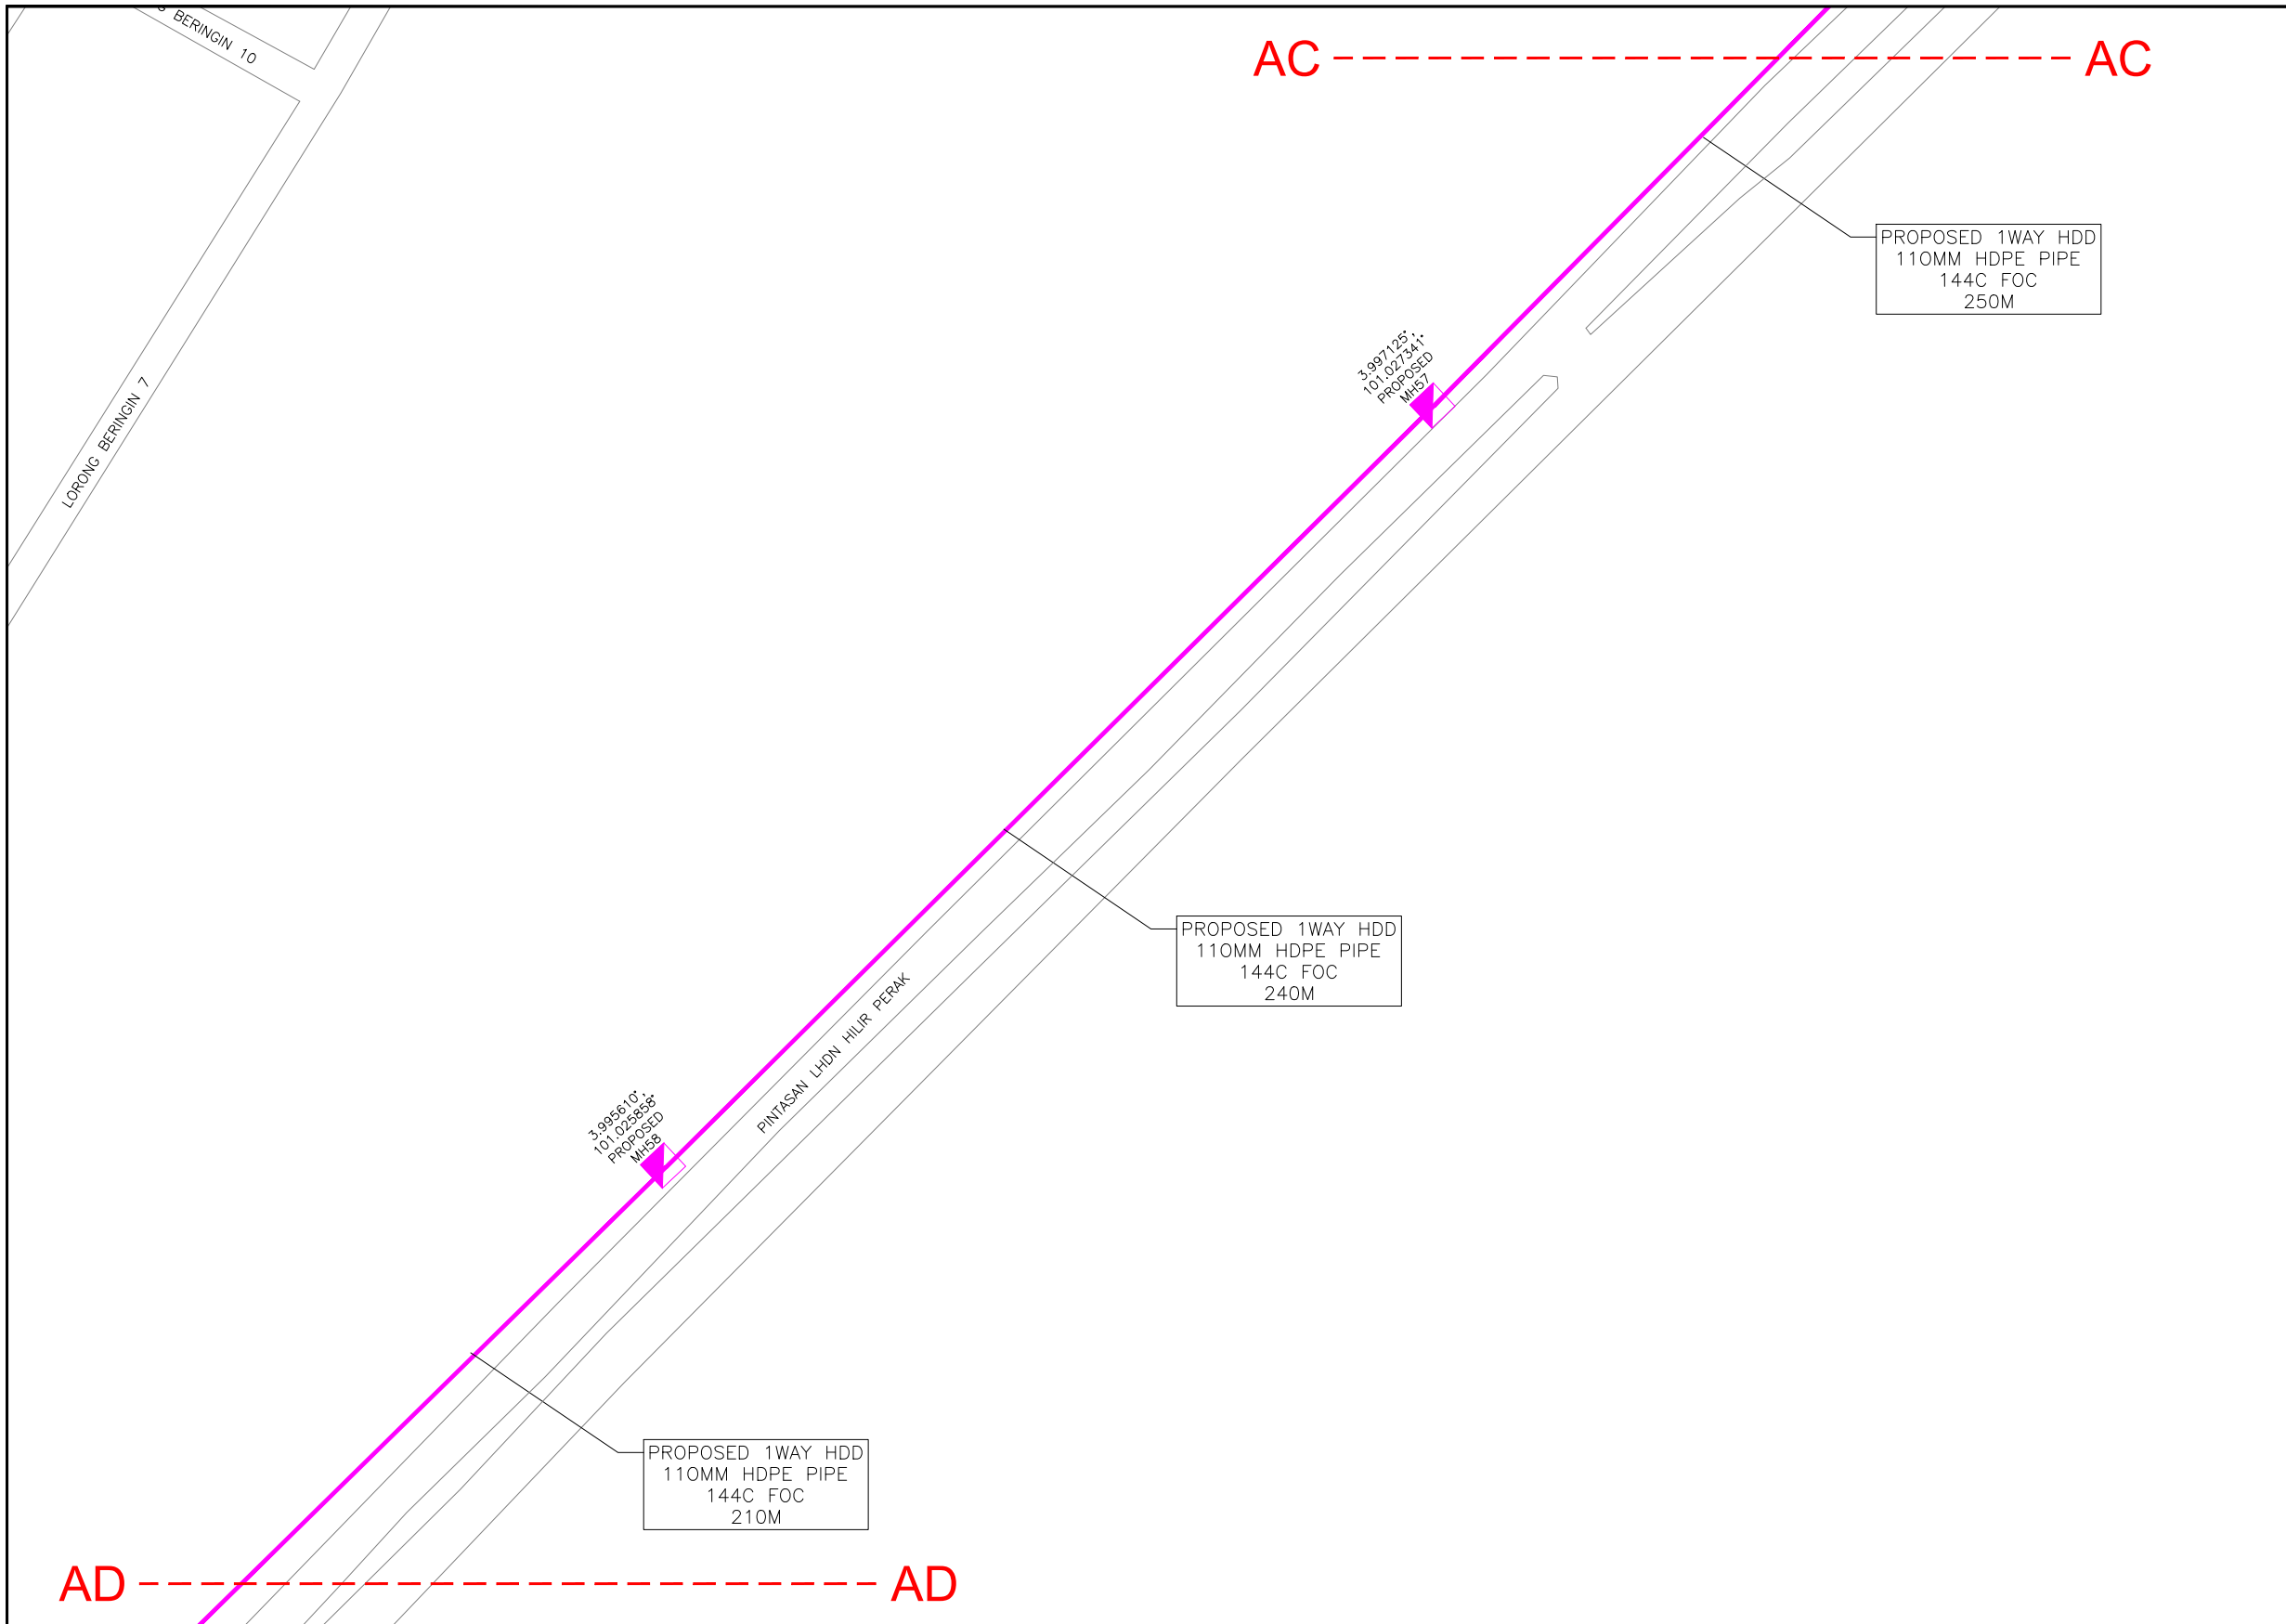

KELULUSAN PLAN

Local Authorities:-

CONFIDENTIALITY

These drawings and details are and shall remain the property of TT dotCom Sdn Bhd. Both are issued in strict confidence and shall not be reproduced, copied or used in any manner without specific written permission from the owner.

LEGEND :- OUTSIDE PLANT

- = BUILDING MANHOLE
- = BUILDING PIT
- = PROPOSED TIME MANHOLE
- = EXISTING TIME MANHOLE
- = PROPOSED TIME DUCT ROUTE
- = PROPOSED TIME DUCT TO BUILDING
- = EXISTING BUILDING DUCT ROUTE
- = EXISTING BUILDING CABLE TRAY
- = PROPOSED TRUNKING
- = PROPOSED CONDUIT
- = CLAIM AREA
- 1W / 2W = 1 WAY OR 2 WAY DUCT
- GI = GALVANISED IRON DUCT
- PVC = PVC DUCT
- = HIDDEN DRAIN
- = VISIBLE DRAIN
- = TREES AND PLANTS

REV. NO.	REV. DATE	REV. BY	DESCRIPTION:




TT dotCom Sdn Bhd (52371-A)  
 No 14, Jalan Majistret U1/26,  
 Hicom Glenmarie Industrial Park  
 40150 Shah Alam, Selangor Darul Ehsan, Malaysia.  
 Tel: +60 3 5032 6000  
 Website: www.time.com.my

PROJECT TITLE:  
 FTK NEW 1W UNDERGROUND CIVIL & 1X144F CABLE PULLING INFRASTRUCTURE FROM BIDOR – H.MELINTANG (PACKAGE 4)

DRAWING TITLE:  
 PROPOSED DRAWING (PREVENTIVE MAINTENANCE WITH ANTI RODENT 144C FIBER)

DRAWING NO: TTdC/0000/UMOB/LEML/0001      SHEET NO: 31 OF 30

DRAWING SCALE: N.T.S	DRAWING UNITS: METER
PREPARED BY: AMTEL RESOURCES SDN BHD	INITIAL & DATE: -
DESIGNED BY: JEMI	INITIAL & DATE: -
CHECKED BY: FAZWAN	INITIAL & DATE: -
APPROVED BY: -	INITIAL & DATE: -

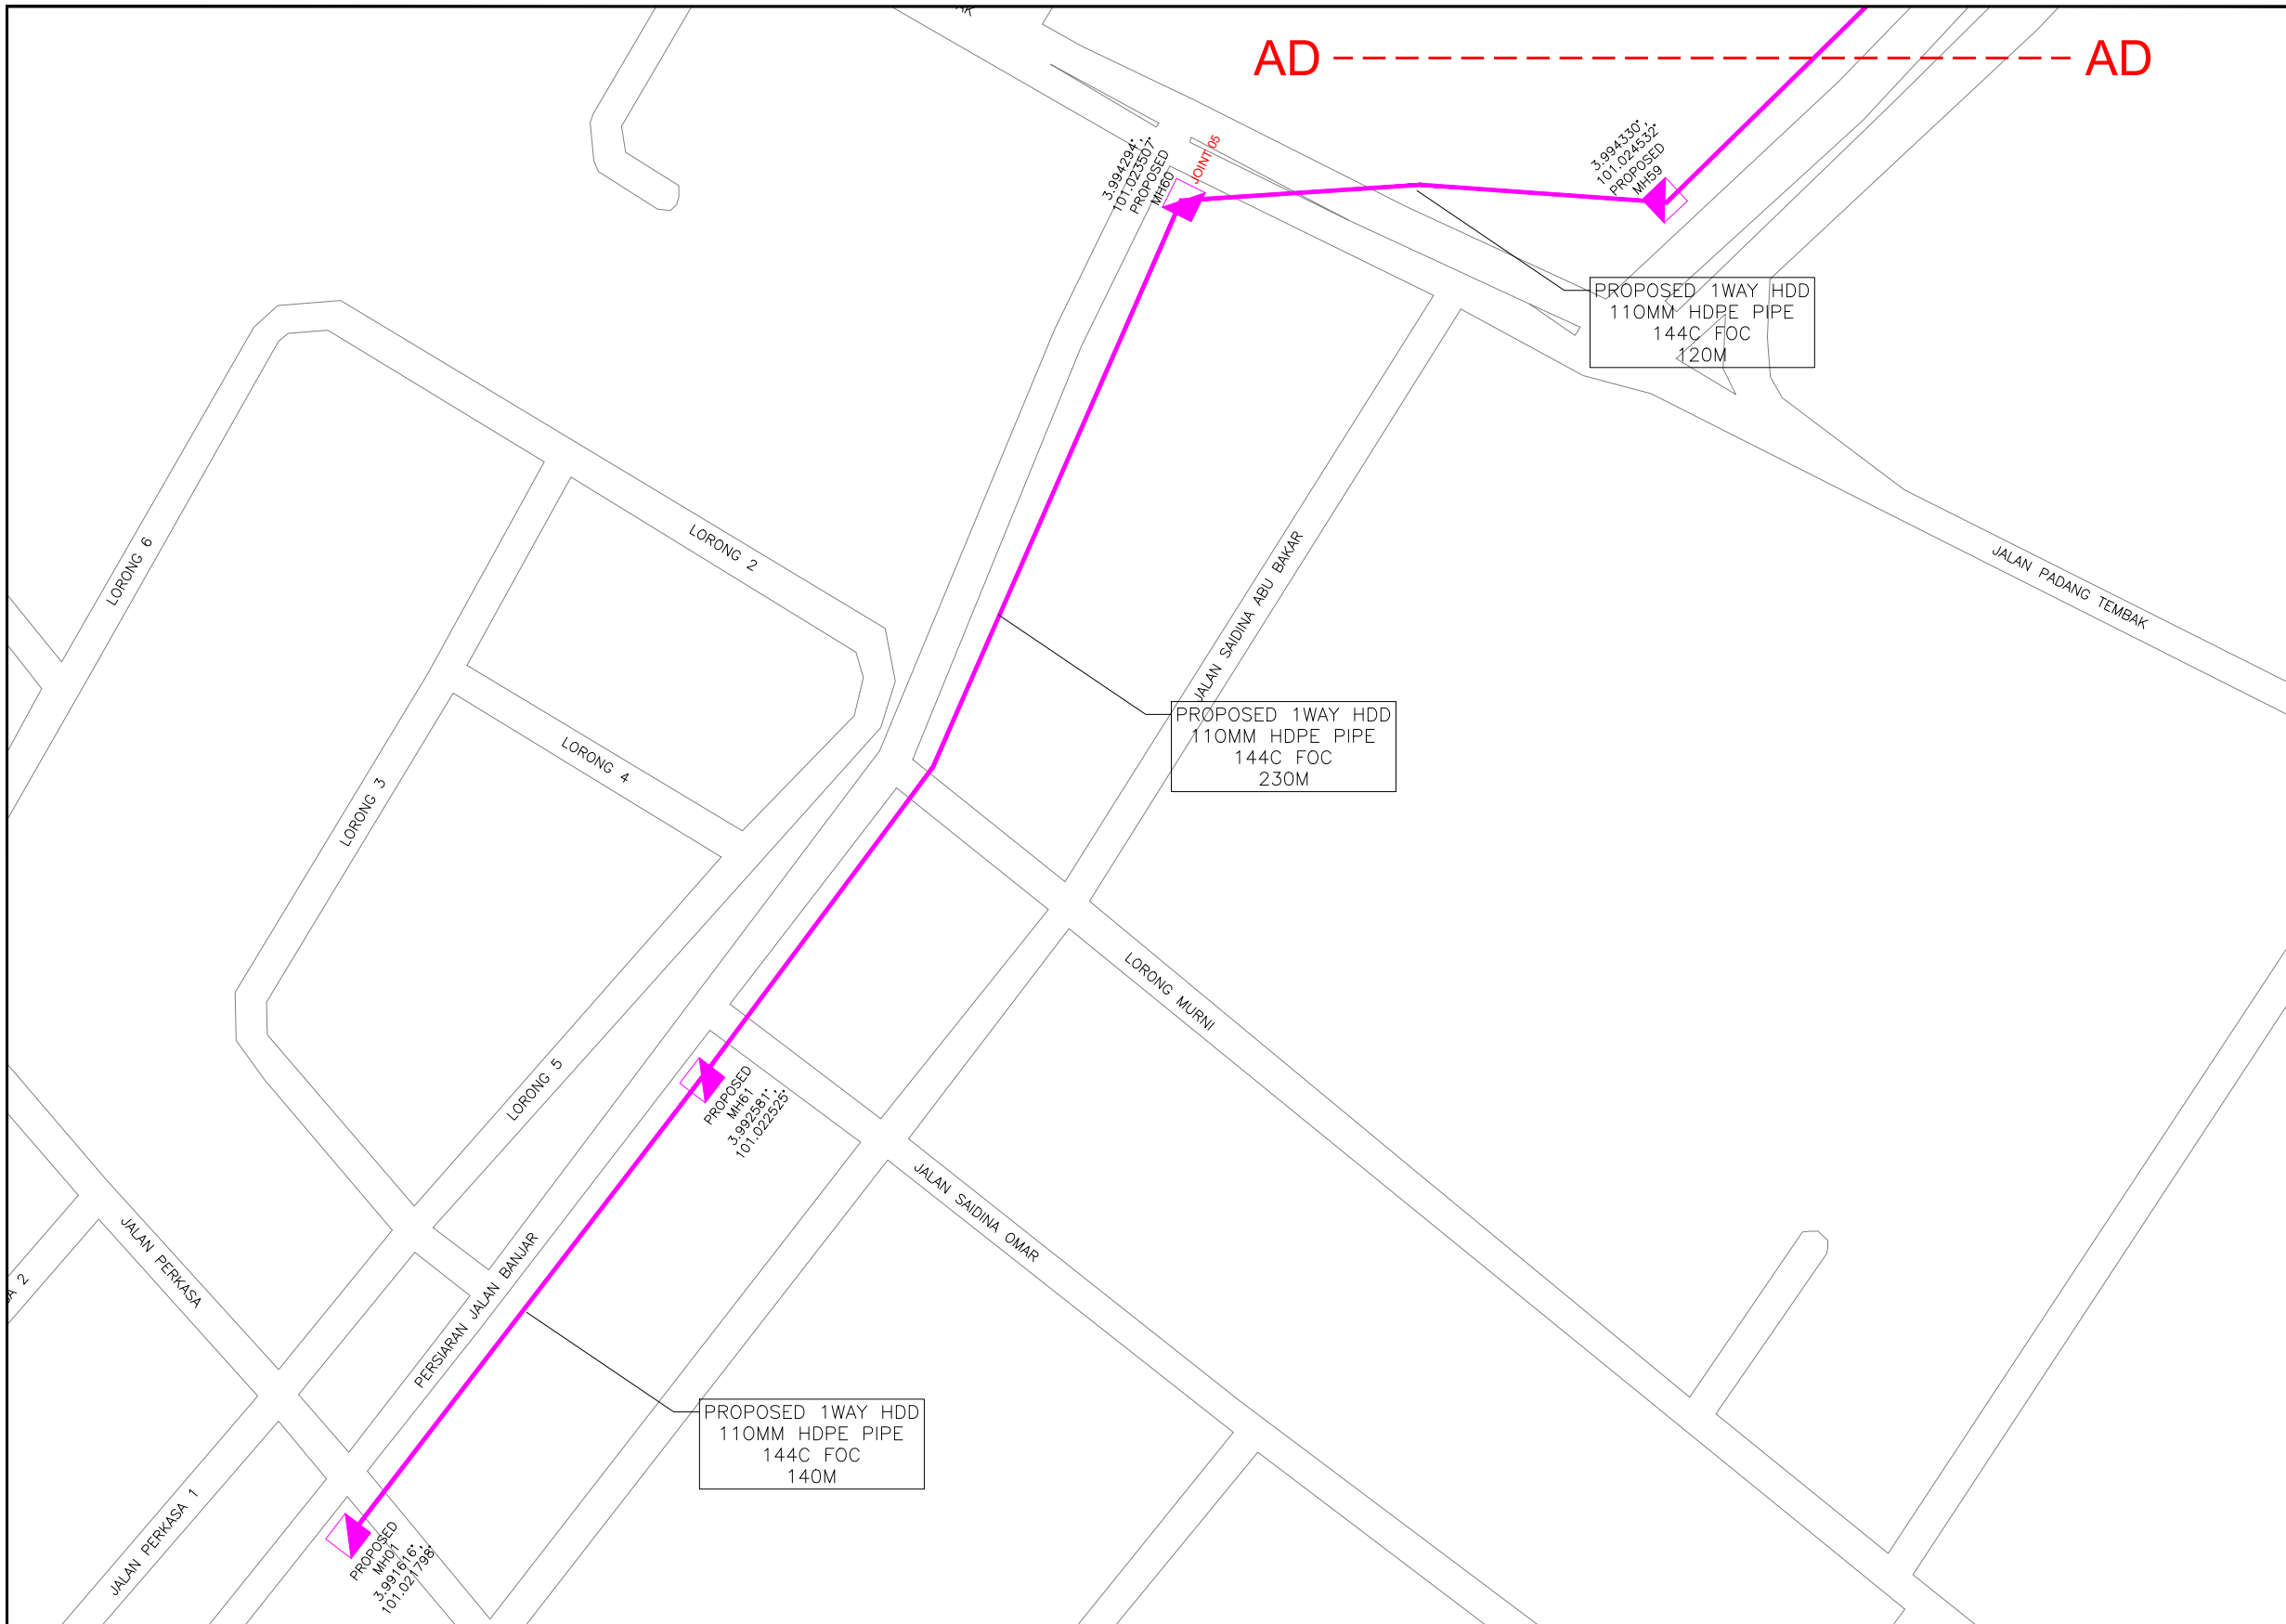

KELULUSAN PLAN

Local Authorities:-

CONFIDENTIALITY

These drawings and details are and shall remain the property of TT dotCom Sdn Bhd. Both are issued in strict confidence and shall not be reproduced, copied or used in any manner without specific written permission from the owner.

LEGEND :- OUTSIDE PLANT

- = BUILDING MANHOLE
- = BUILDING PIT
- = PROPOSED TIME MANHOLE
- = EXISTING TIME MANHOLE
- = PROPOSED TIME DUCT ROUTE
- = PROPOSED TIME DUCT TO BUILDING
- = EXISTING BUILDING DUCT ROUTE
- = EXISTING BUILDING CABLE TRAY
- = PROPOSED TRUNKING
- = PROPOSED CONDUIT
- = CLAIM AREA
- 1W / 2W = 1 WAY OR 2 WAY DUCT
- GI = GALVANISED IRON DUCT
- PVC = PVC DUCT
- = HIDDEN DRAIN
- = VISIBLE DRAIN
- = TREES AND PLANTS

REV. NO.	REV. DATE	REV. BY	DESCRIPTION:



TT dotCom Sdn Bhd (52371-A)  
 No 14, Jalan Majistret U1/26,  
 Hicom Glenmarie Industrial Park  
 40150 Shah Alam, Selangor Darul Ehsan, Malaysia.  
 Tel: +60 3 5032 6000  
 Website: www.time.com.my

PROJECT TITLE: FTK NEW 1W UNDERGROUND CIVIL & 1X144F CABLE PULLING INFRASTRUCTURE FROM BIDOR – H.MELINTANG (PACKAGE 4)
DRAWING TITLE: PROPOSED DRAWING (PREVENTIVE MAINTENANCE WITH ANTI RODENT 144C FIBER)
DRAWING NO: TTdC/0000/UMOB/LEML/0001
SHEET NO: 31 OF 31

DRAWING SCALE: N.T.S	DRAWING UNITS: METER
PREPARED BY: AMTEL RESOURCES SDN BHD	INITIAL & DATE: -
DESIGNED BY: JEMI	INITIAL & DATE: -
CHECKED BY: FAZWAN	INITIAL & DATE: -
APPROVED BY: -	INITIAL & DATE: -

SURVEY ACKNOWLEDGEMENT FORM

Building / Customer Name: Bidor – Hutan Melintang Package 4  
Site Address: Perak Darul Ridzuan

It is hereby to confirm that the contactor, .....  
Has visited the above site and has done the survey accordingly.

Thank you.

Surveyed by;

.....  
Name : Jem  
Surveyor



Confirmed by;

.....  
Name :  
Building Manager/Reps.  
Chop: